



NOTE: A MINIMUM 10' HORZ. AND 18" VERT. SEPARATION (WITH WATER MAIN ON TOP) IS REQUIRED BETWEEN WATER AND SEWER LINES.

SEWER PIPE MAIN BEDDING DETAIL
SCALE: NTS

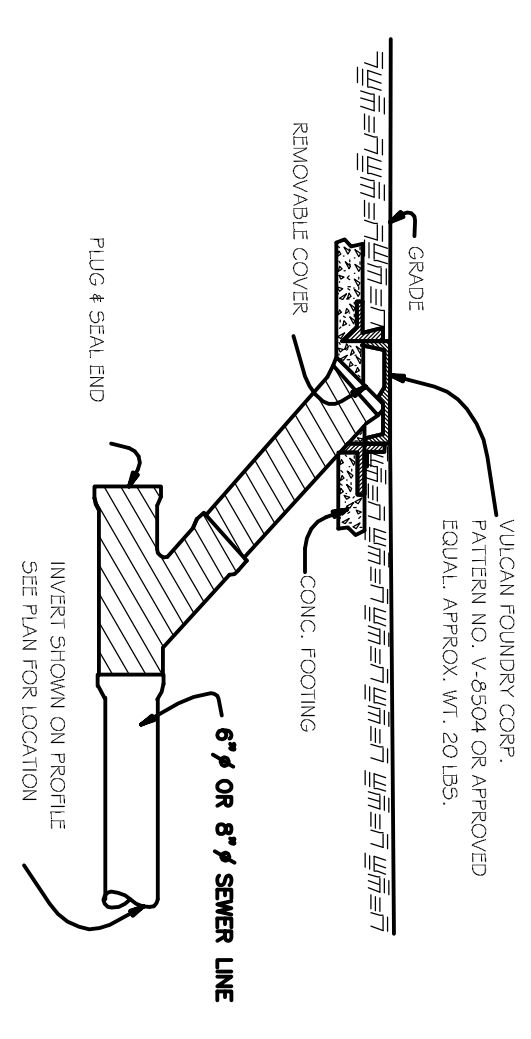

CLEANOUT DETAIL
SCALE: NTS

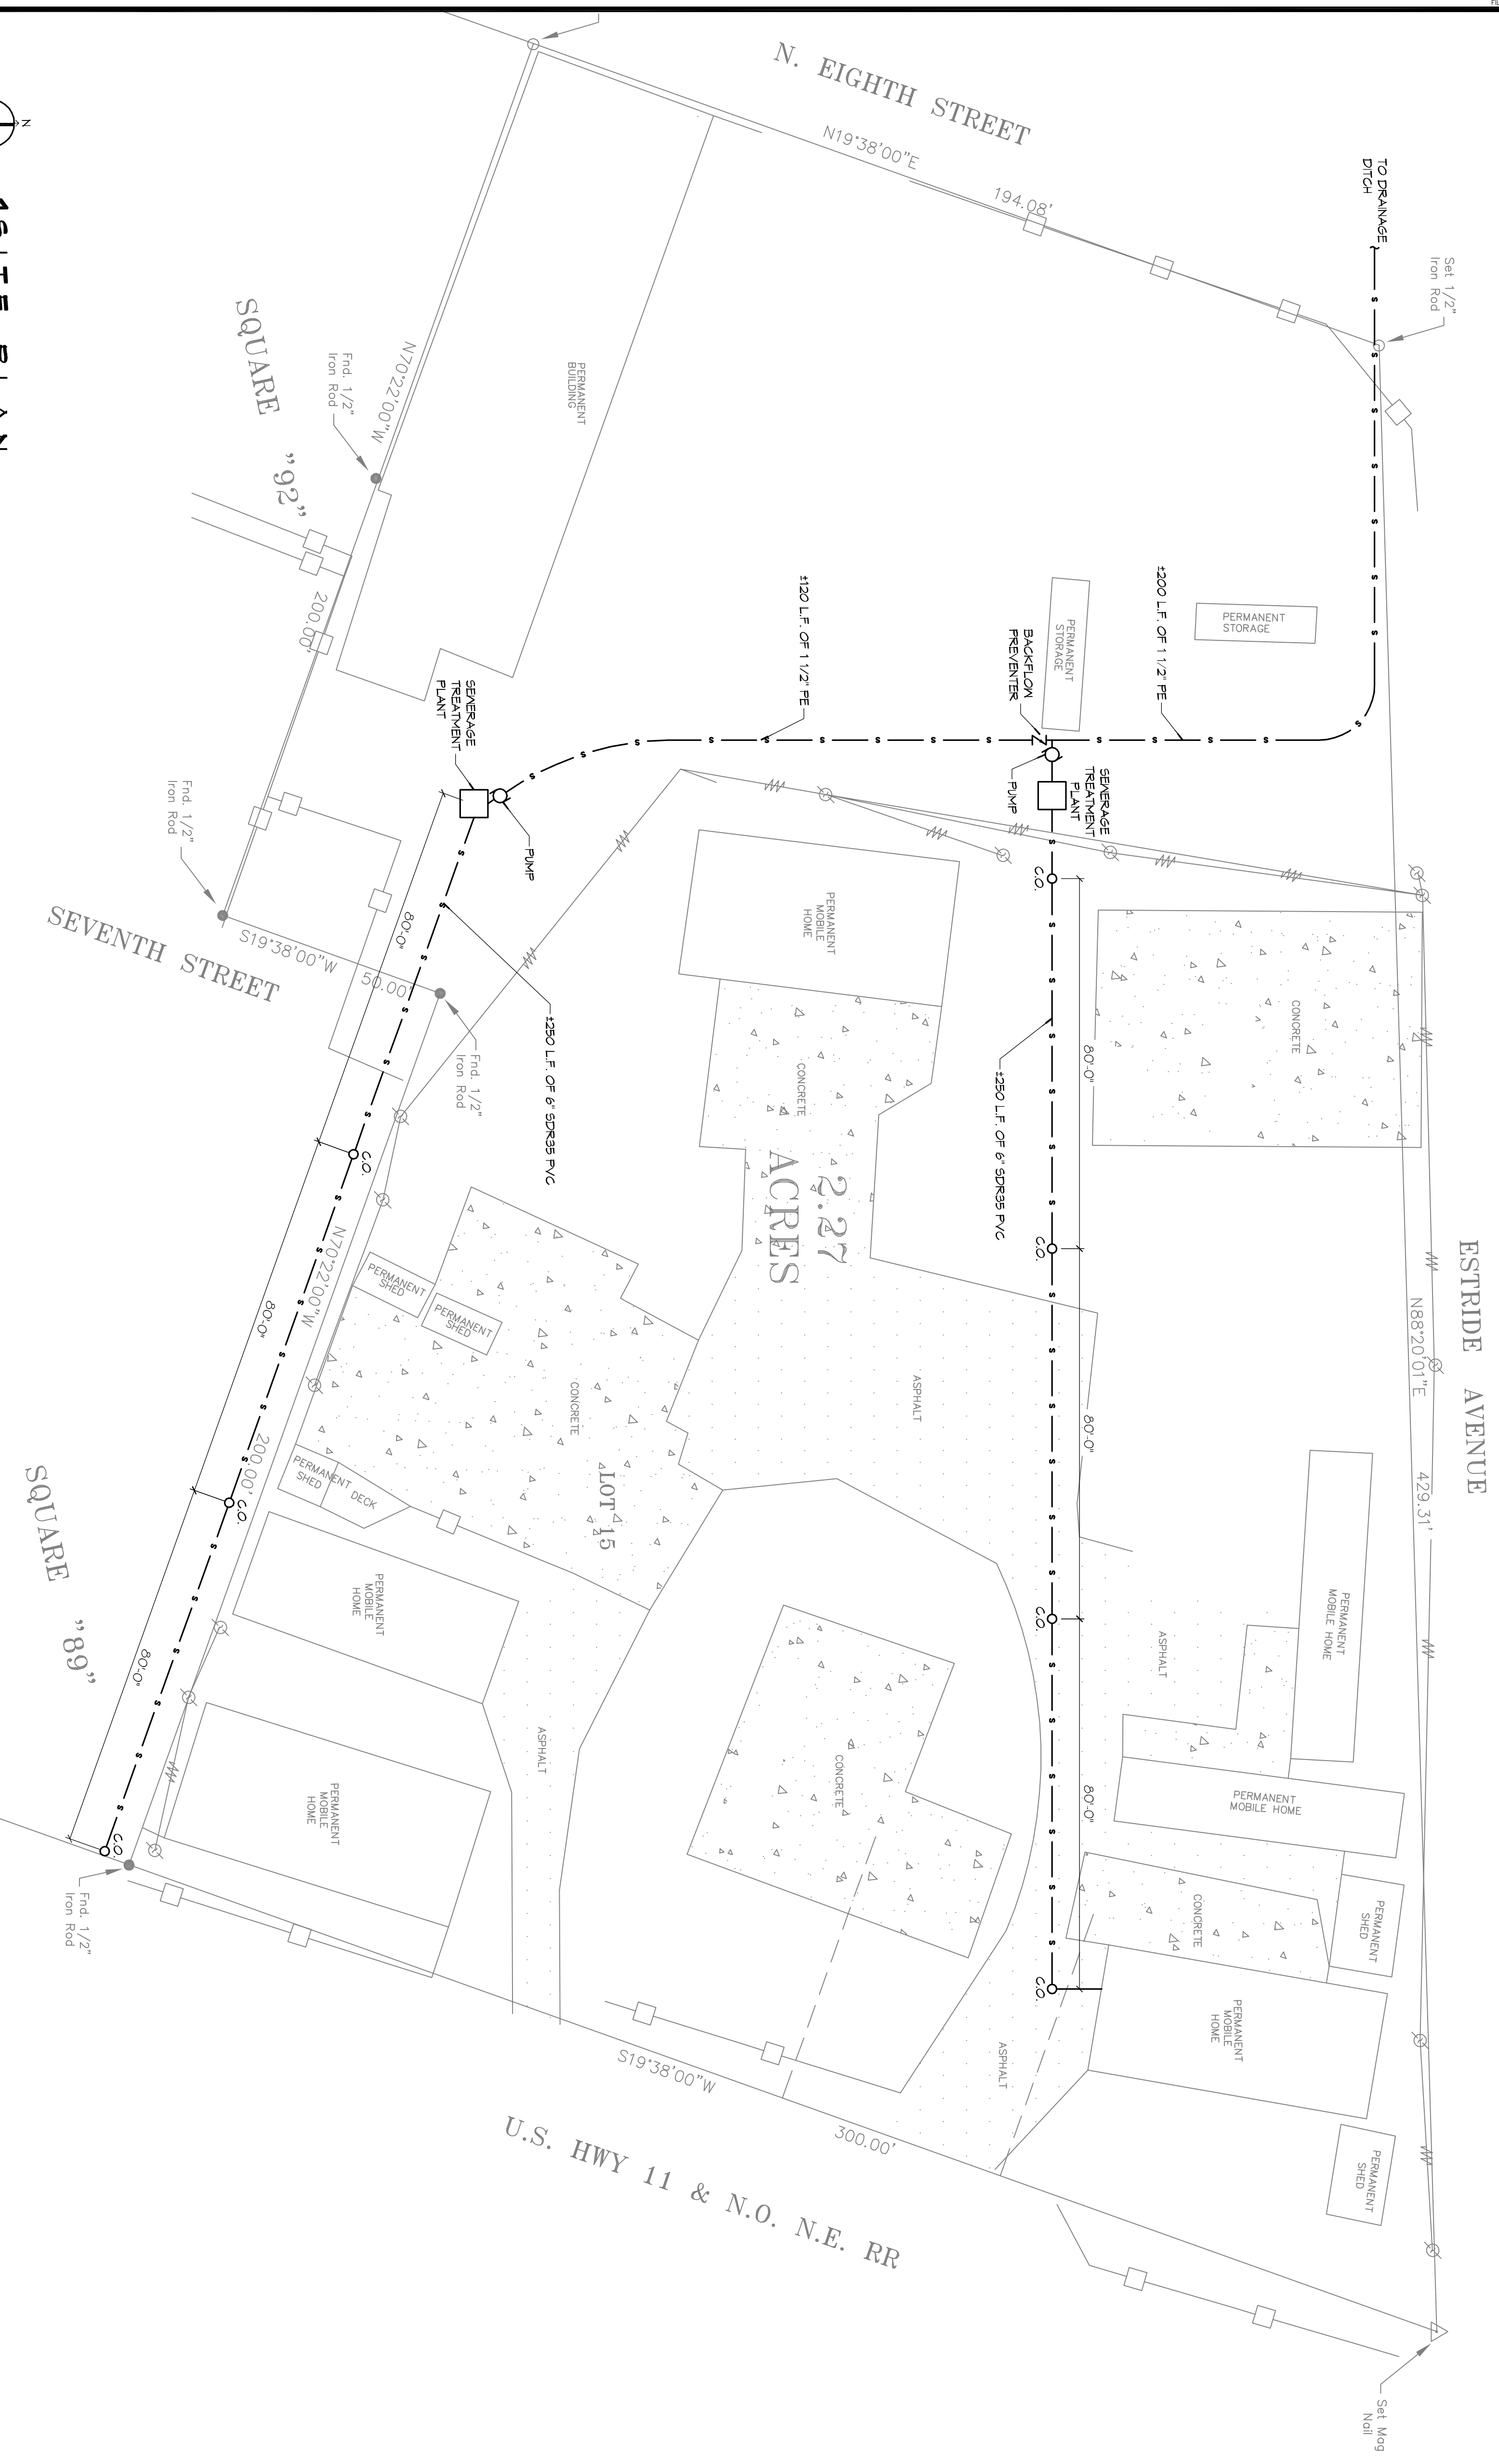

1 SITE PLAN
SCALE: 1" = 20'

SITE UTILITIES NOTES

1. MINIMUM PIPE BURIAL TO BE 36 INCHES.
2. SEWER PIPE TO BE 6" SDR35 PVC UDN.
3. 6" CLEANOUTS EVERY 80 FEET, STARTING FROM HIGHEST END.

GENERAL NOTES

1. PROVIDE ALL LABOR, MATERIALS AND EQUIPMENT FOR A COMPLETE OPERATING SYSTEM.
2. ALL WORK AND MATERIAL SHALL CONFORM STRICTLY TO THE LATEST LOCAL, CITY, COUNTY, STATE AND NATIONAL GOVENING CODES.
3. CONTRACTOR IS TO VERIFY ALL EXISTING UTILITY LOCATIONS, DEPT. OF PUBLIC WORKS RECORDS AND FIELD SURVEY. CONTRACTOR SHALL PAY NECESSARY FEES FOR THE UTILITIES CONNECTIONS.
4. CONTRACTOR IS RESPONSIBLE TO SET NEW INVERTS OF SEWERAGE PIPES.
5. 4-INCH SEWER LINES SHALL BE SLOPED 1/8" PER FOOT.
6. TEST ALL PIPING AT REQUIRED PRESSURE.
7. ALL FLOWING SHALL BE CLOSETLY MONITORED WITH WATER SYSTEM.
8. ALL SEWER LINES SHOWN ARE DIAGRAMMATIC.
9. MINIMUM PIPE MAIN BURIAL SHALL BE 3'-0".
10. OWNER SHALL IDENTIFY TRAILER SPACING FOR CONTRACTOR TO LAYOUT SEWER WORK.

SITE UTILITIES LEGEND

- NEW SEWER LINE
- Z BACKFLOW PREVENTER
- CLEANOUT
- WASTEWATER PUMP
- SEWERAGE TREATMENT PLANT

DAMMON ENGINEERING, INC.
LOUISIANA & MISSISSIPPI

Chief Engineer: Brian Mistch, PE
554 Old Spanish Trail
Stidell, LA 70458
www.dammoneengineering.com
Info@dammoneengineering.com
PH: 985.649.5832 F: 985.641.5950

REVISIONS	DATE
# DESCRIPTION	

SCALE: **PRELIMINARY NOT FOR CONSTRUCTION**

GUS MITCHELL SQUARE 89 & 92
ALTON ST. TAMMANY PARISH, LOUISIANA

JOB No: _____ DATE: FEBRUARY, 2016
DRAWN BY: NHM CHECKED BY: CKD

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SHEET TITLE: **SEWER LAYOUT**

DRAWING NUMBER: **C-2**

SHEET No: **C-2**