

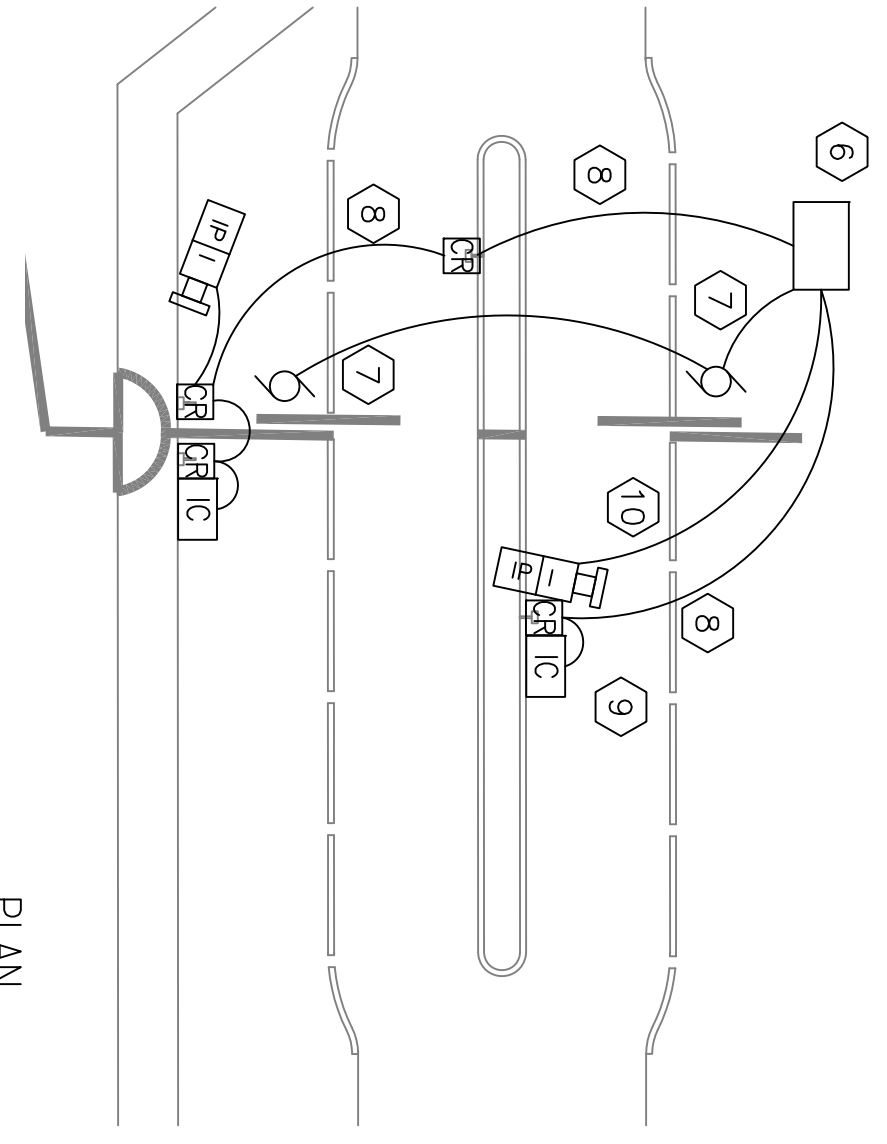



**SITE PLAN - SPECIAL SYSTEMS**  
 SCALE: 1"=40'-0"  
 0 20' 40' 80'

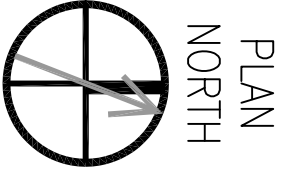

**DETAIL - VEHICLE GATES**  
 SCALE: 1/16"=1'-0"  
 0 8' 16' 32'

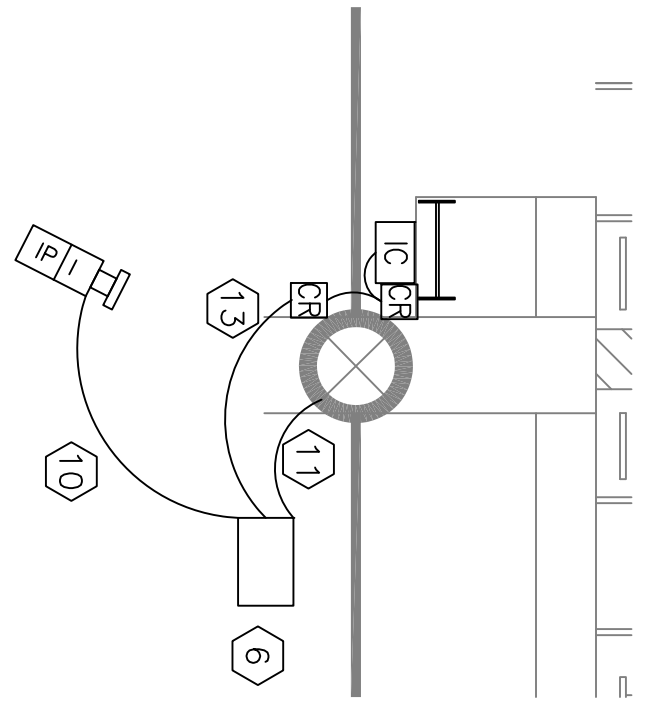

**DETAIL - PEDESTRIAN GATE**  
 SCALE: 1/16"=1'-0"  
 0 8' 16' 32'

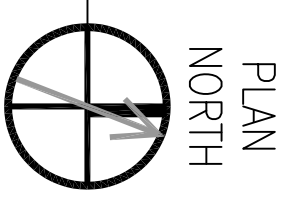

**SPECIFIC NOTES THIS SHEET:**

- 1 6-4"C, CONCRETE ENCASED. SEE SHEET E2.4 FOR CONTINUATION.
- 2 CONCRETE MANHOLE, 6'X12', WITH H2O CAST IRON COVER MARKED COMMUNICATIONS.
- 3 6-4"C AND 4-2"C ROUTED INTO BUILDING AND TERMINATING IN SECOND FLOOR TEL/COMM ROOM #202. SEE SHEET E5.1 FOR FURTHER DETAILS.
- 4 4-2"C ROUTED TO BLDG 2442, AND STUBBED UP INTO JUNCTION BOX ON INTERIOR. SEE SHEET E5.3 FOR FURTHER DETAILS.
- 5 1-2"C.
- 6 11"X18" PULLBOX, OPEN BOTTOM, POLYMER CONCRETE, HEAVY DUTY COVER MARKED COMMUNICATIONS. QUAZITE PC1118BA18 WITH PC1118HA0012 COVER.
- 7 3/4"C ROUTED TO GATE MOTOR CONTROLLER. REFERENCE GATE SHOP DRAWINGS AND WIRING DIAGRAMS FOR INTERCONNECTION REQUIREMENTS TO CARD READERS. PROVIDE ADDITIONAL CONDUIT FOR SENSOR LOOPS AND LIMIT SWITCHES AS REQUIRED BY GATE INSTALLER.
- 8 3/4"C ROUTED TO CARD READER PEDESTAL.
- 9 MOUNT INTERCOM STATION ON TOP OF CARD READER PEDESTAL. PROVIDE 3/4"C INTO PEDESTAL BASE.
- 10 3/4"C ROUTED TO CCTV CAMERA MOUNTED ON TOP OF FENCE.
- 11 3/4"C ROUTED TO PEDESTRIAN GATE POWER SUPPLY FOR AS ELECTRIC STRIKE. PROVIDE RELAY AND INTERCONNECTION AS REQUIRED TO RELEASE STRIKE.
- 12 3/4"C ROUTED TO INTERCOM STATION MOUNTED NEXT TO CARD READER ON PEDESTRIAN GATE.
- 13 3/4"C ROUTED TO CARD READER MOUNTED ON PEDESTRIAN GATE.
- 14 1"C ROUTED FROM LIFT STATION CONTROL PANEL TO MANHOLE, FOR FUTURE TELEMETRY SYSTEM MONITORING.
- 15 1"C ROUTED FROM JUNCTION INSIDE BLDG 2442 TO PULLBOX. SEE SHEET E5.3 FOR FURTHER DETAILS.

THESE PLANS AND SPECIFICATIONS HAVE BEEN PREPARED BY OR UNDER OUR DIRECT SUPERVISION, AND WE ARE NOT PROVIDING CONTRACT ADMINISTRATION. WE ARE NOT GENERALLY ADMINISTERING THE WORK.

SCHLARLY ENGINEERING LLC  
 PER: [Signature]  
 REG. # 27899  
 9-4-09

SYM	DESCRIPTION	DATE	APPR

**NAVFAC**  
 SCHLARLY ENGINEERING LLC  
 121 SOUTH GENOIS STREET  
 FARM OREANS, LA 70119  
 PHN: 504-462-1344  
 FAX: 504-462-1980  
 M. KIMBALL SCHLARLY, P.E.  
 LA REG. 27899

STATE OF LOUISIANA  
 M. KIMBALL SCHLARLY  
 REG. NO. 27899  
 PROFESSIONAL ENGINEER  
 IN  
 ELECTRICAL ENGINEERING

DES: K. SCHLARLY/DWG: K. SCHLARLY  
 REVIEWED BY: R. WILTSIE  
 P.N./CHK: T. ARMBR  
 CHIEF ENG./ARCH: P. DAMON

DEPARTMENT OF THE NAVY  
 NAVAL FACILITIES ENGINEERING COMMAND  
 NAVAL FACILITIES ENGINEERING COMMAND SOUTHEAST  
 NAVAL AIR STATION JACKSONVILLE  
 MISSISSIPPI  
 JOHN C. STENNIS SPACE CENTER  
**SOF RIVERINE AND COMBATANT CRAFT OPERATIONS FACILITY**  
**SITE PLAN - SPECIAL SYSTEMS**

CODE ID NO. N4412	SIZE 0
SCALE AS SHOWN	#####
MAKNO NO. P-210	512047
WORK ORDER NO. N62467-05-D-0096	15026725
NAVFAC DRAWING NO. 15026725	SHEET 108 OF 132
<b>E2.3</b>	