




C.1 SIDE WALK SECTION
SCALE: 1/32" = 1'-0"
TYPICAL

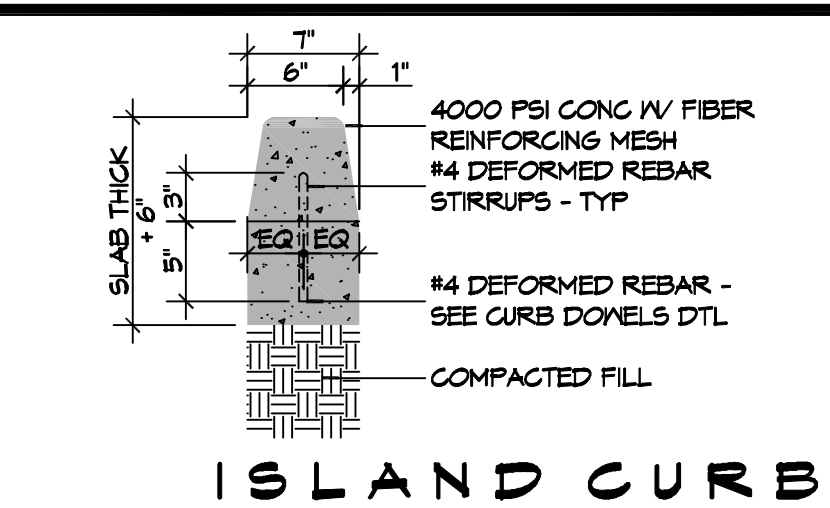


D ISLAND CURB SECTION
SCALE: 1" = 1'-0"
TYPICAL

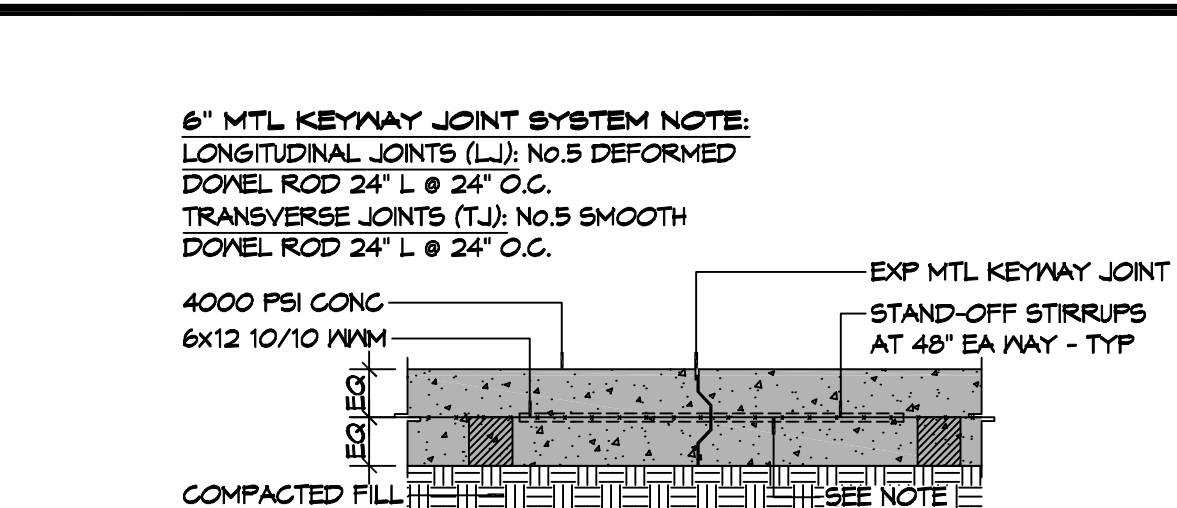


E WHEEL STOP SECTION
SCALE: 1" = 1'-0"
TYPICAL

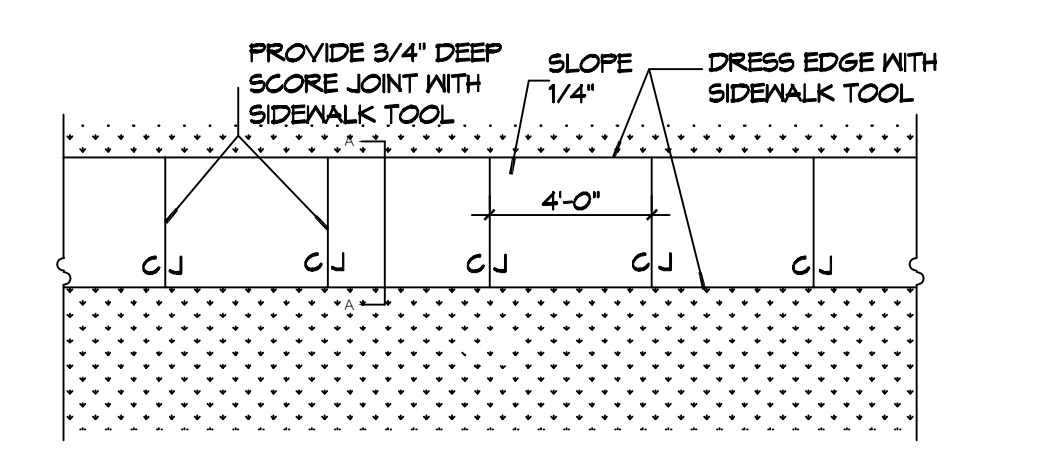

C.2 SIDE WALK PLAN
SCALE: 1/32" = 1'-0"
TYPICAL

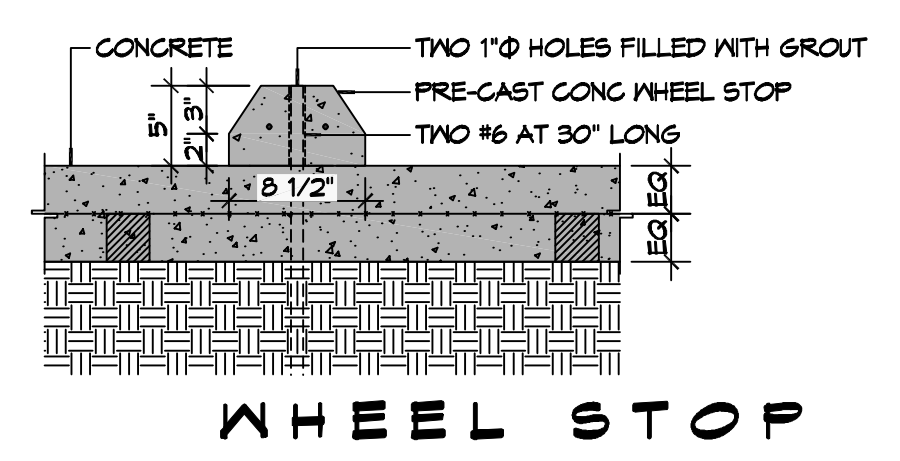

F EXISTING PAVING TO NEW PAVING
SCALE: 1" = 1'-0"
TYPICAL

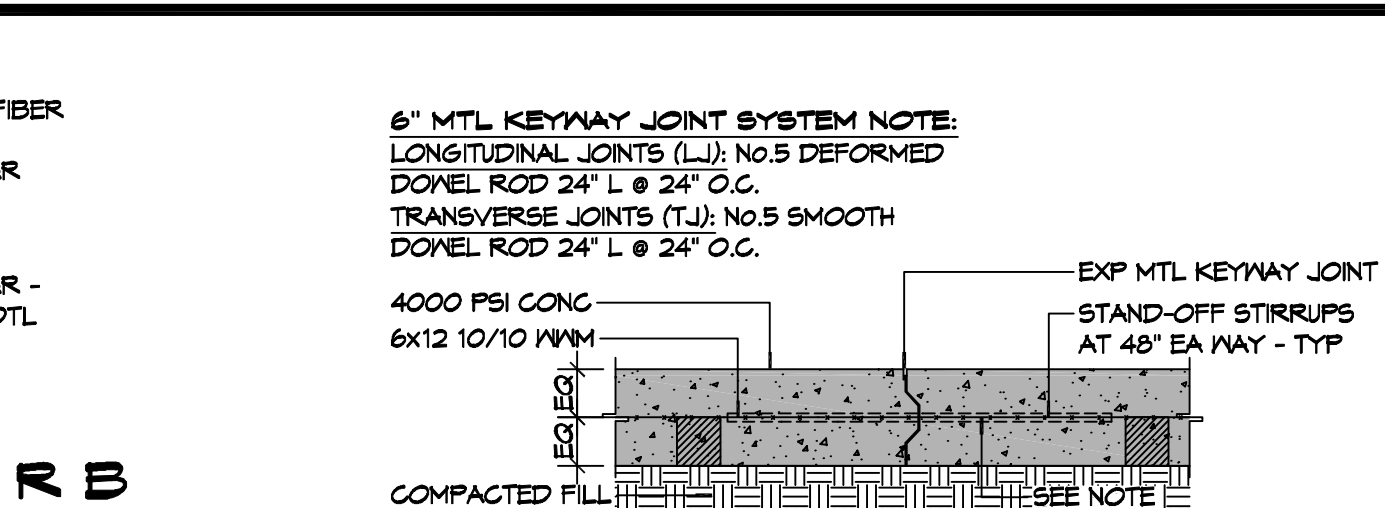


G APRON PLAN VIEW
SCALE: 3/4" = 1'-0"
TYPICAL

GENERAL PAVING NOTES

- ALL NEW CONCRETE SHALL HAVE A MINIMUM COMPRESSIVE STRENGTH OF 4,000 PSI AT 28 DAYS AND A MINIMUM THICKNESS OF 6". CONCRETE MIX SHALL BE IN ACCORDANCE WITH THE LATEST REVISION OF ASTM C-150 TYPE 1.
- CONCRETE PAVING THICKNESS SHALL VARY AS FOLLOWS:
 - APRONS & LOADING AREAS = 8" THICKNESS (INDICATED WITH CROSS HATCH WHERE OCCURS)
 - DRIVE LANES & PARKING AREAS = 6" THICKNESS (STANDARD UNO)
- ALL REINFORCING STEEL SHALL MEET ASTM-A615 (GRADE 60).
- ALL REINFORCING STEEL SHALL BE SECURELY SUPPORTED TO PREVENT BOTH VERTICAL AND HORIZONTAL MOVEMENT DURING CONCRETE PLACEMENT. ALL CONTROL AND EXPANSION JOINTS SHALL BE LOCATED AND INSTALLED AS SHOWN ON THE PAVING PLAN AND IN ACCORDANCE WITH THE MANUFACTURER'S RECOMMENDATIONS.
- ALL SUB GRADE FILL SHALL BE SELECT GRANULAR MATERIAL COMPACTED TO 95% STANDARD PROCTOR DENSITY IN A MAXIMUM OF 6" LIFTS.
- ANY WORK WITHIN THE ROADWAY OR ADJACENT TO THE ROADWAY CAUSING AN INTERFERENCE TO VEHICULAR TRAFFIC MUST CONFORM TO THE REQUIREMENTS SET FORTH BY THE UNIFORM MANUAL OF TRAFFIC CONTROL DEVICES OF THE STATE OF LOUISIANA. THE CONTRACTOR MUST FURNISH ALL NECESSARY TRAFFIC SIGNS AND/OR BARRICADES AND MAINTAIN THEM DURING CONSTRUCTION ACTIVITY.

PAVING LEGEND

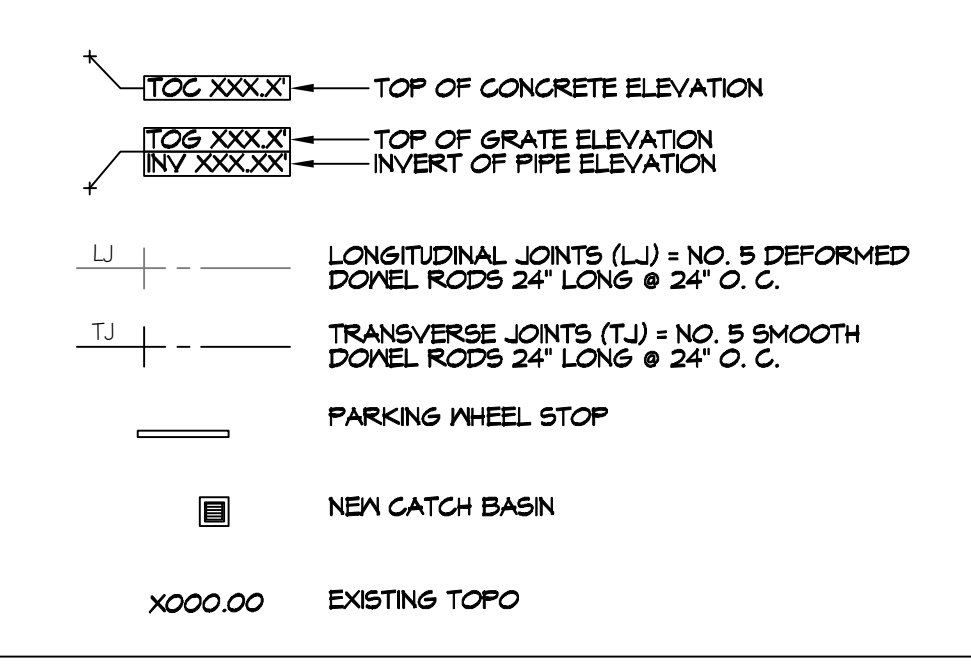


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PH: 985.649.5832

#	DESCRIPTION	DATE
1	REVISED PER ENGINEERING	04-26-22



NEW BUILDING
DREW MANUAL
40081 CORAL STREET
SLIDELL, LA 70461
JOB No: DATE: 12-14-2021
DRAWN BY: C&D CHECKED BY: BAW

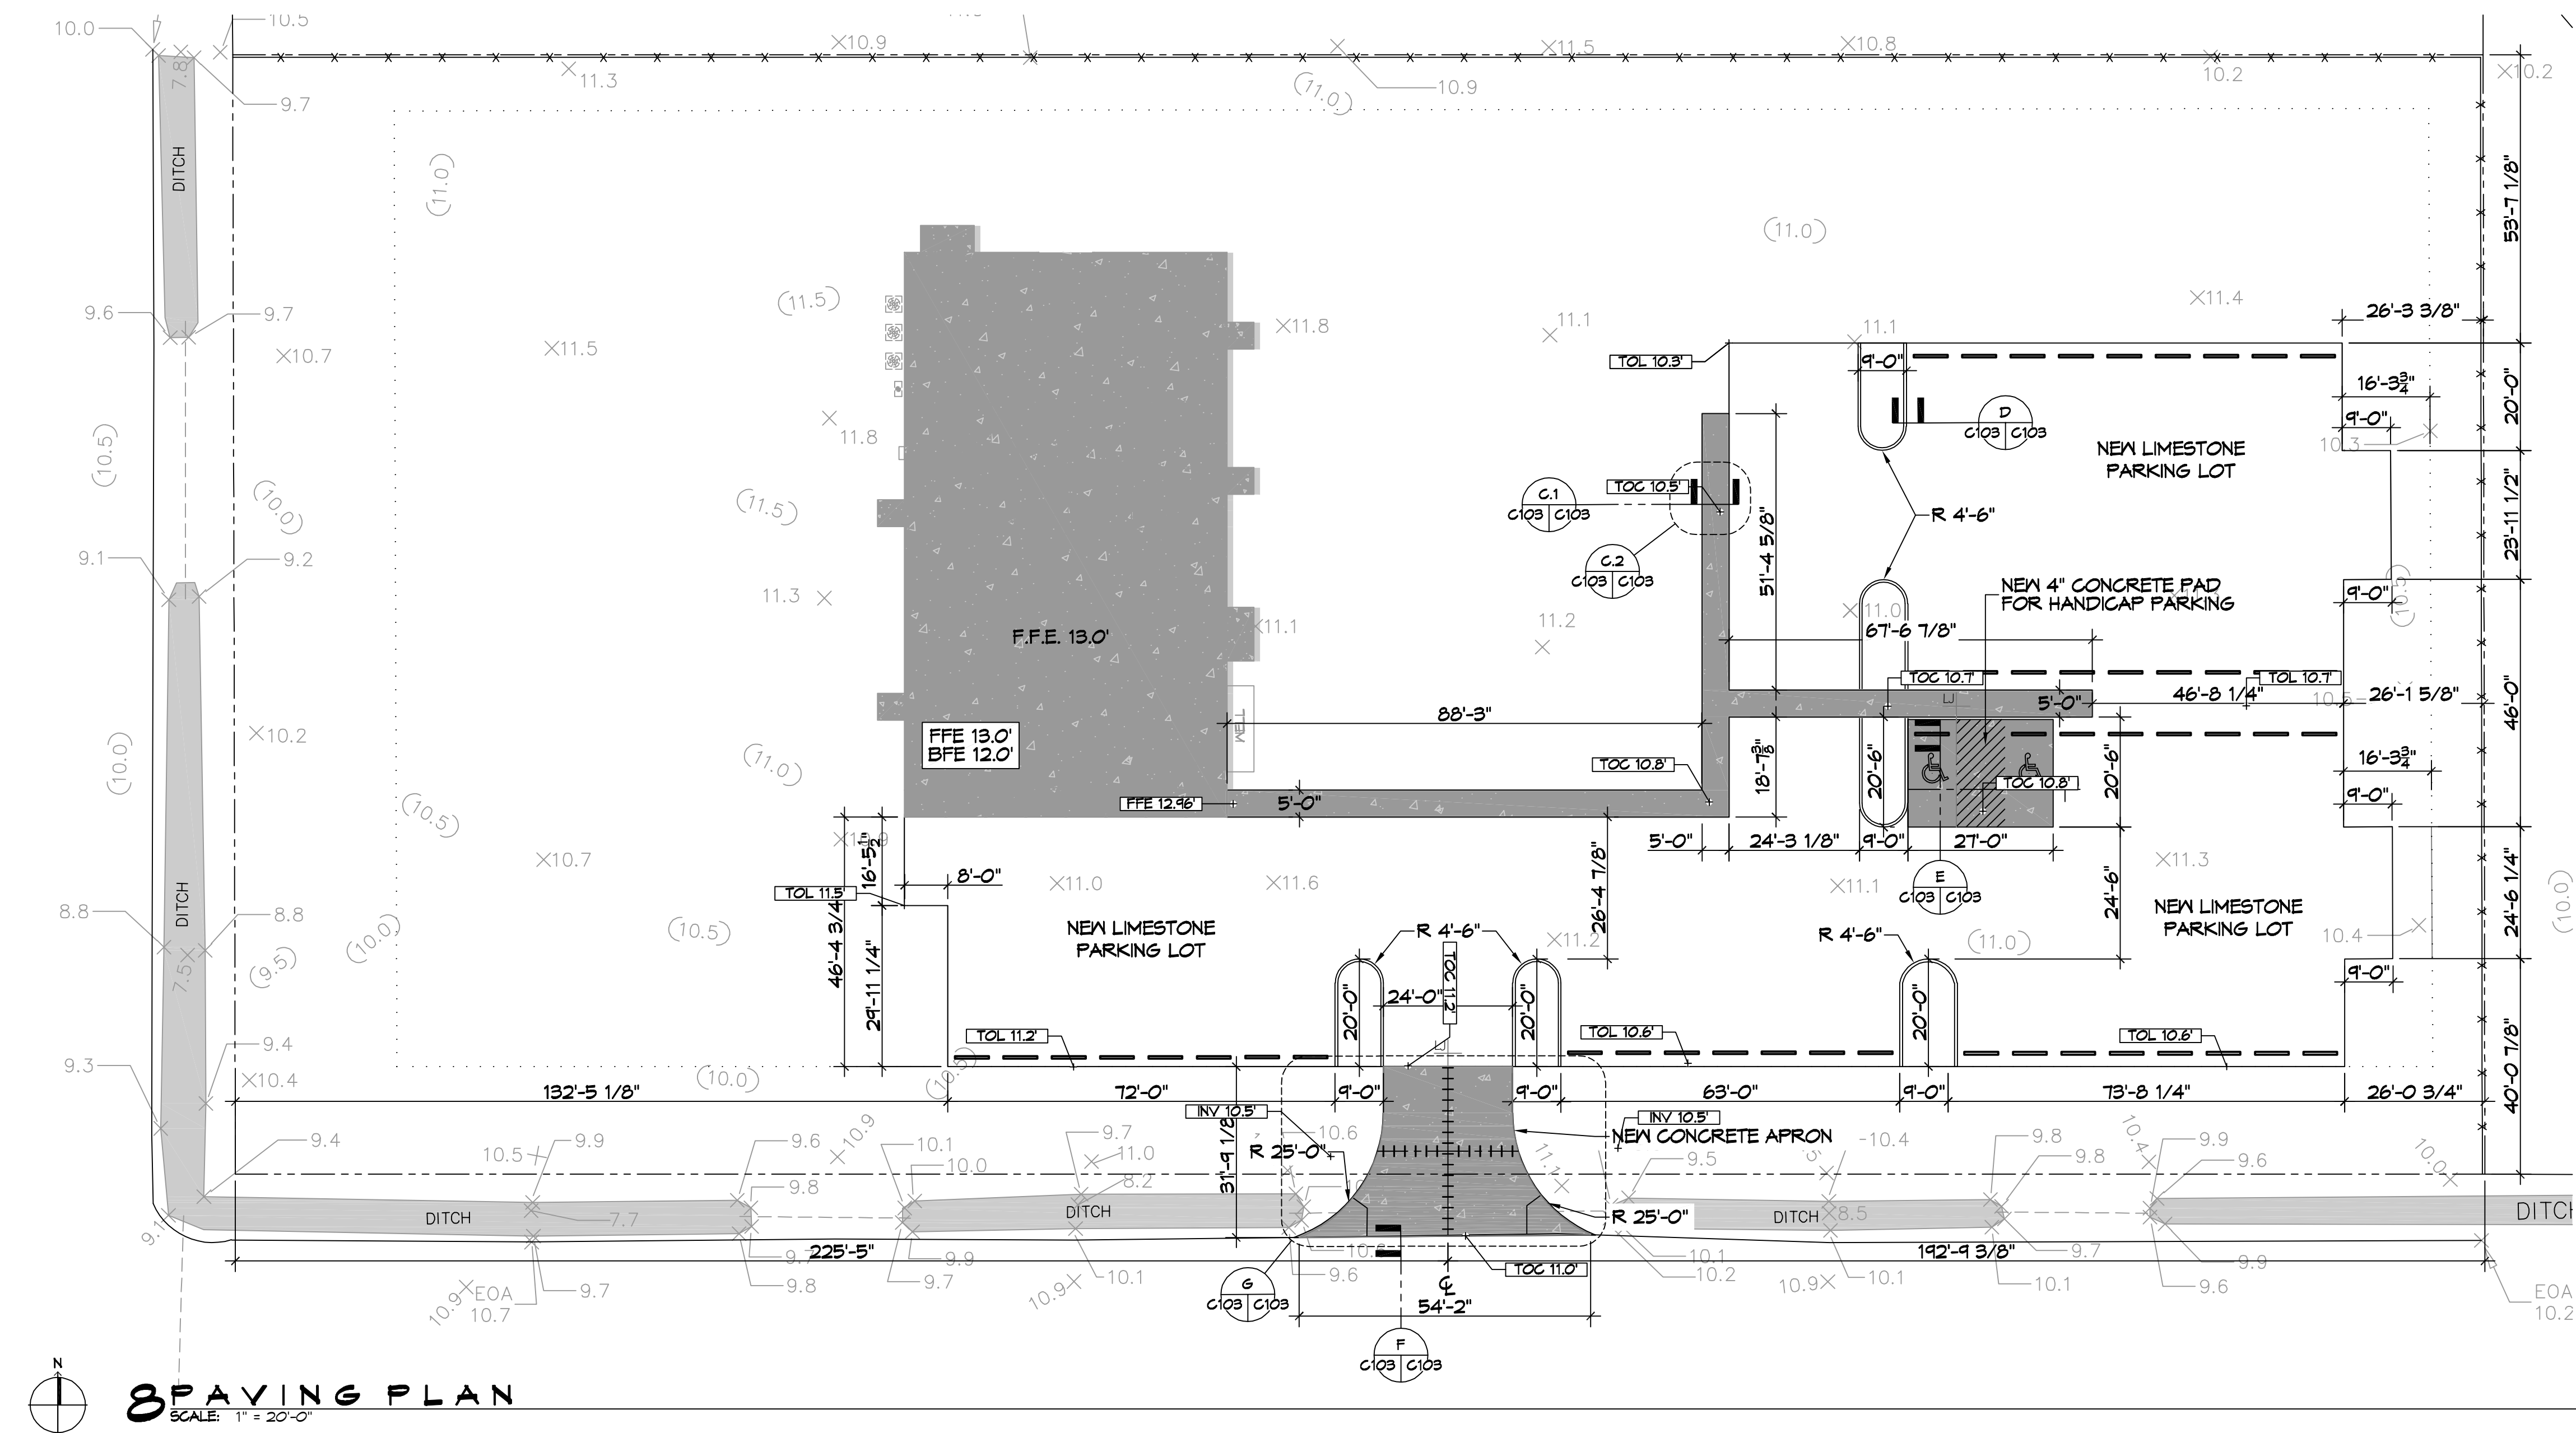

8 PAVING PLAN
SCALE: 1" = 20'-0"