


PHILLIPS

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CONSULTANT

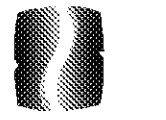

PHILLIPS NORTH TERRACES 400 PERIMETER CENTER TERRACE SUITE 650 ATLANTA, GA 30346

SEAL

ISSUE & REVISION RECORD

#	DATE	DESCRIPTION
	07/07/14	BID SET

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PROJECT

SPRINGS AT FREMAUX TOWN CENTER SLIDELL, LA

CLIENT

CONTINENTAL PROPERTIES CONTINENTAL 294 FUND LLC W134 N8675 EXECUTIVE PARKWAY MEMPHIS FALLS, WI 53051 262.502.5500 * FAX 262.502.5522

PHILLIPS JOB NUMBER 1333104

ISSUE DATE 07/07/14

DRAWN BY/CHECKED BY PEM

DRAWING TITLE

UNIT 2GO - MECHANICAL PLAN

SHEET NUMBER

M4.2GO

NORTH TERRACES 400 PERIMETER CENTER TERRACE SUITE 650 ATLANTA, GEORGIA 30346

CONDENSATE PIPING NOTES:


- DIRECT PRIMARY CONDENSATE LINES TO HUB DRAINS LOCATED IN MECHANICAL CLOSETS. REFER TO PLUMBING PLANS FOR LOCATION, ROUTING AND REQUIREMENTS. WHERE BUILDING HAS MULTIPLE STORIES, HUB DRAINS SHALL BE INSTALLED AT FIRST FLOOR ONLY. CONDENSATE PIPES FROM UNITS ABOVE SHALL BE RUN INDIVIDUALLY AND FULL SIZE TO DISCHARGE INDIRECTLY INTO THE HUB DRAIN ON THE LOWEST FLOOR. ALL HORIZONTAL SECTIONS OF DRAIN PIPING SHALL BE INSTALLED IN UNIFORM ALIGNMENT AT A UNIFORM SLOPE. MINIMUM 1%.
- AN AUXILIARY DRAIN PAN SHALL BE PROVIDED UNDER THE UNIT. SUCH PAN SHALL BE EQUIPPED WITH A WATER-LEVEL DETECTION DEVICE THAT WILL SHUT OFF THE UNIT UPON DETECTION OF WATER. PAN CONSTRUCTION SHALL BE PER CODE REQUIREMENTS.
- CONDENSATE DRAINS SHALL BE TRAPPED PER MANUFACTURERS RECOMMENDATIONS.

DRYER EXHAUST NOTES:


- ALL CLOTHES DRYER DUCTS PENETRATING OR LOCATED WITHIN ANY FIRE BLOCKING DRAFT STOPPING OR ANY WALL, FLOOR, CEILING OR OTHER ASSEMBLY REQUESTED BY THE BUILDING CODE TO BE FIRE-RESISTANT SHALL BE CONSTRUCTED OF RIGID METAL DUCTWORK, GALVANIZED STEEL OR ALUMINUM, WITH A MINIMUM THICKNESS OF GAUGE 28 TO 24 RESPECTIVELY AS SPECIFIED IN THE SMACNA DUCT CONSTRUCTION STANDARDS AND CURRENT EDITION OF THE INTERNATIONAL MECHANICAL CODE.
- CONTRACTOR SHALL INSTALL RECESSED DRYER VENT BOX "IN-O-VENT TECHNOLOGIES" MODEL 425 TO ELIMINATE BENDS IN FLEX EXHAUST DUCT.
- UNLESS NOTED OTHERWISE THE DRYER VENT OUTLET SHALL BE LOCATED A MINIMUM 3'-0" FROM THE OPERABLE PORTION OF ALL WINDOWS AND OTHER AIR INTAKES.
- ON MULTI-STORY BUILDINGS, ROUTE DRYER VENT FROM TOP FLOOR TO AN APPROVED SOFFIT.
- EXHAUST DUCTWORK SHALL BE SUPPORTED AT 4'-0" INTERVALS.
- PROTECTIVE SHIELD PLATES SHALL BE PLACED PER LATEST EDITION OF INTERNATIONAL MECHANICAL CODE.
- PROVIDE A PERMANENT LABEL TO IDENTIFY THE EQUIVALENT LENGTH OF THE CONCEALED EXHAUST DUCT. THE LABEL SHALL BE PERMANENTLY ATTACHED IN A VISIBLE LOCATION WITHIN 6'-0" OF DRYER CONNECTION.
- DRYER VENT TOTAL EQUIVALENT LENGTH CAN BE SIGNIFICANTLY REDUCED USING LONG RADIUS ELBOWS. REFER TO TABLE 504.5.4.1 INTERNATIONAL MECHANICAL CODE FOR DUCT FITTING EQUIVALENT LENGTHS. CONTRACTOR SHALL PROVIDE FITTINGS AS INDICATED ON PLANS.

TOTAL EQUIVALENT DRYER EXHAUST LENGTH	
TOTAL LENGTH	38 FT.
NUMBER OF 90° ELBOWS	1
NUMBER OF 45° ELBOWS	1
TOTAL EQUIVALENT LENGTH	45.5 FT

BOOSTER FAN IS NOT REQUIRED BASED ON THIS MODEL. SEE DETAIL 7 ON SHEET M6.02. IF DIFFERENT MODEL IS USED BOOSTER FAN MAY BE REQUIRED.

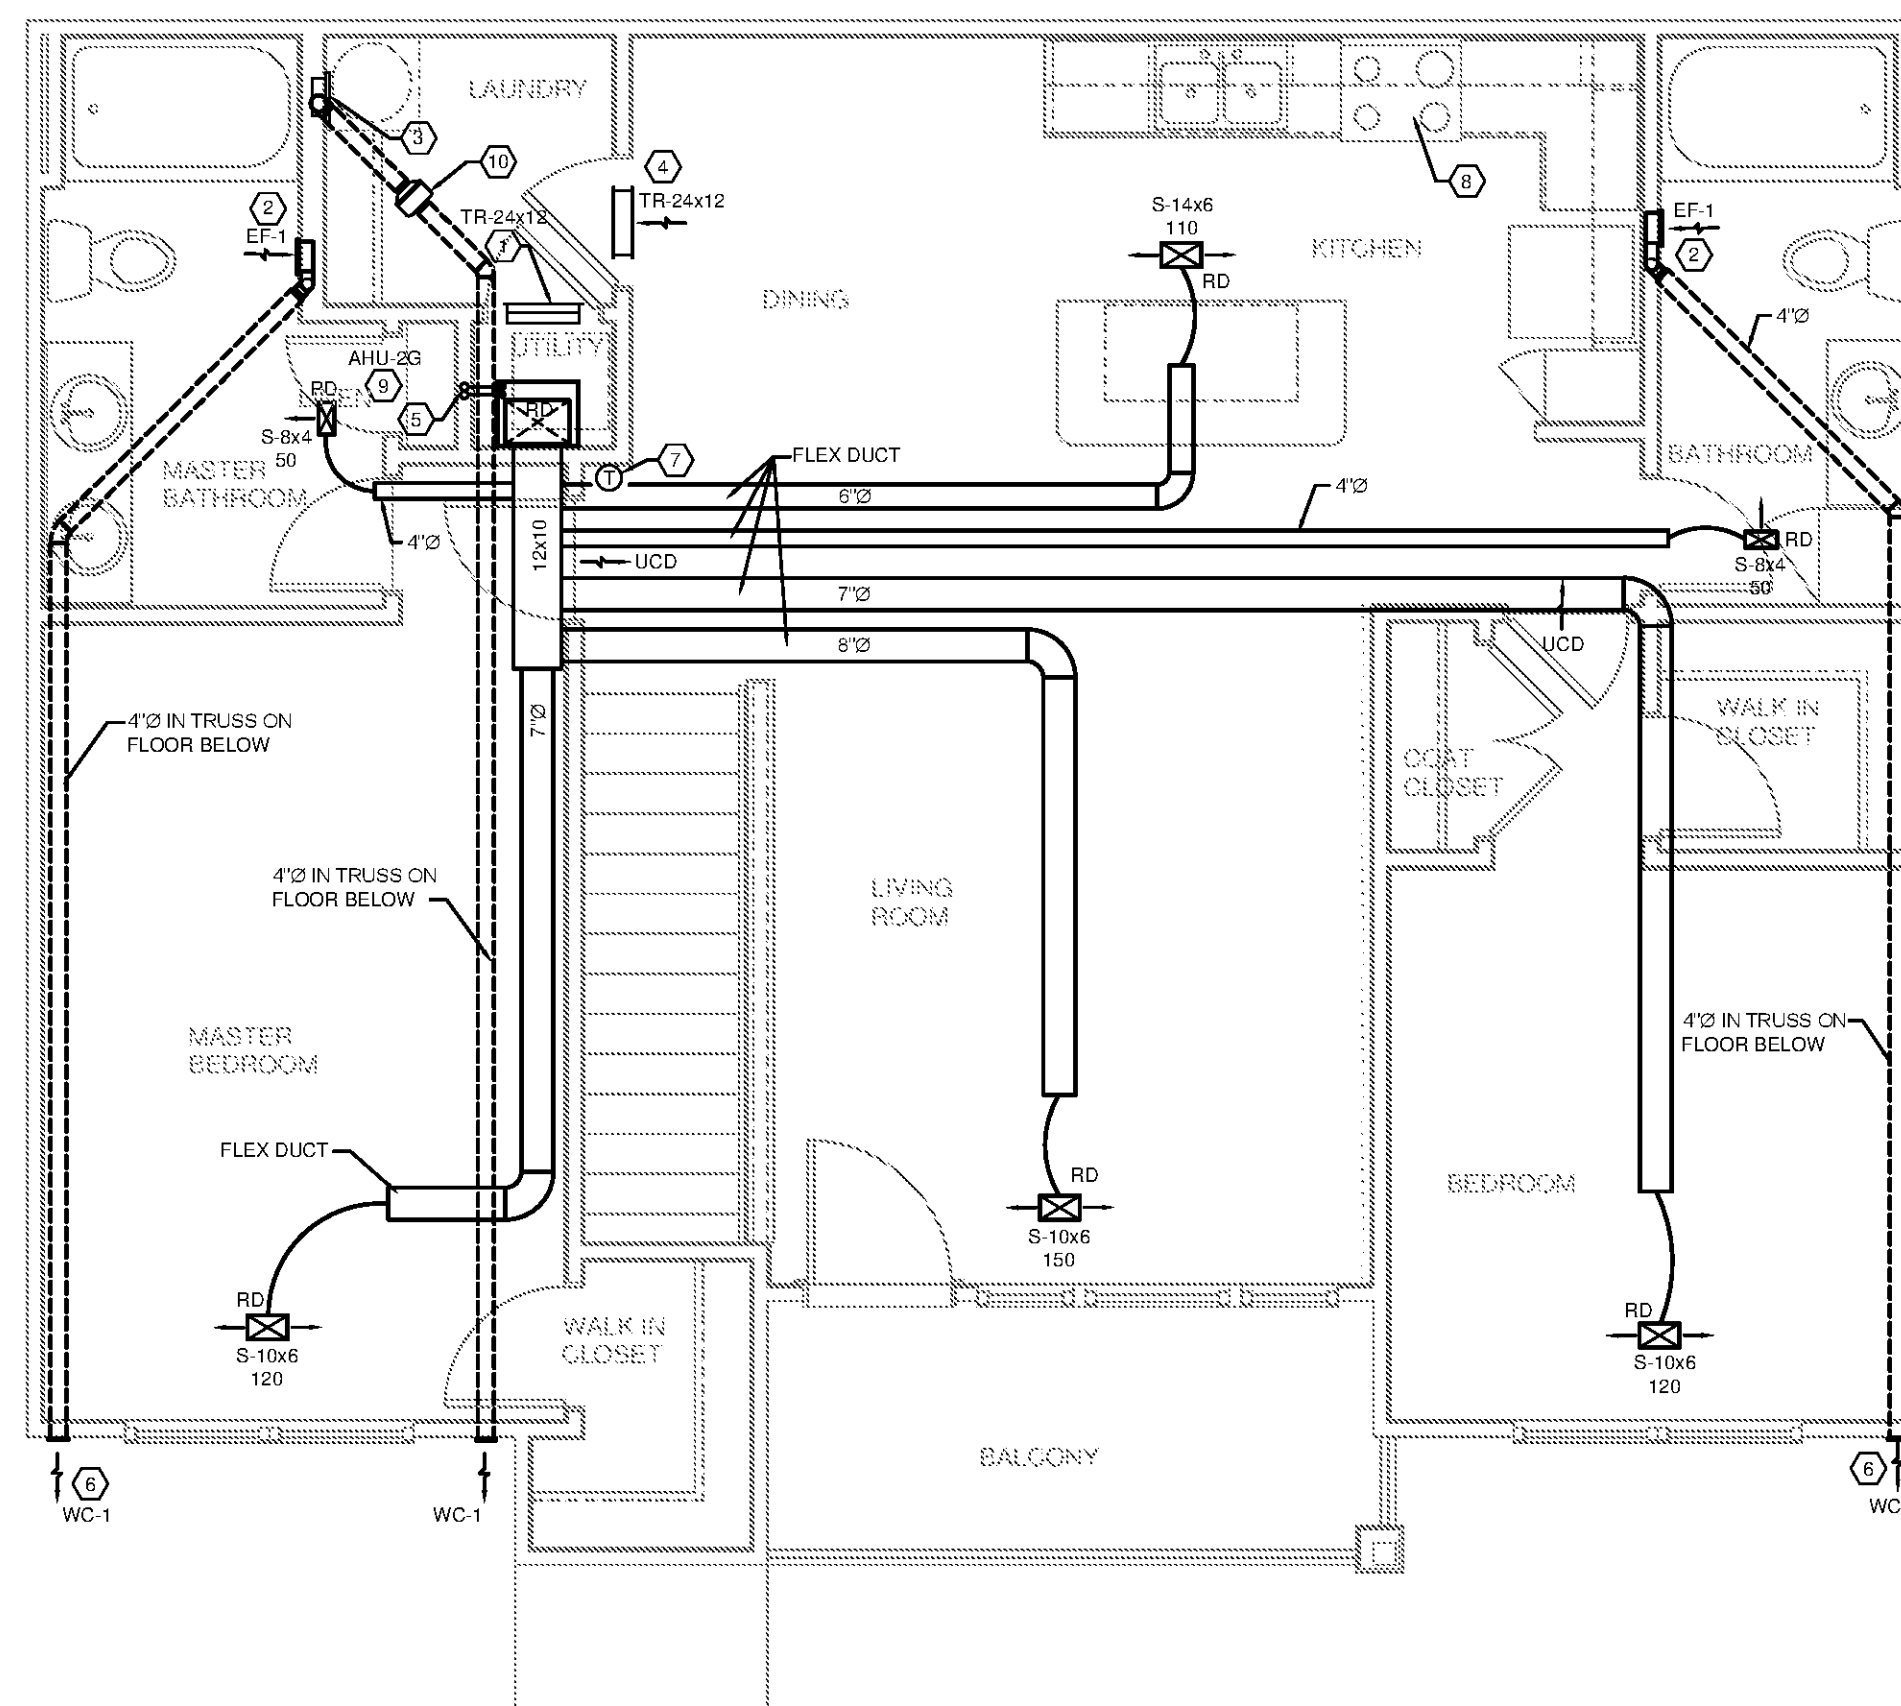

UNIT 2GO - MECHANICAL PLAN 1/4" = 1'-0"

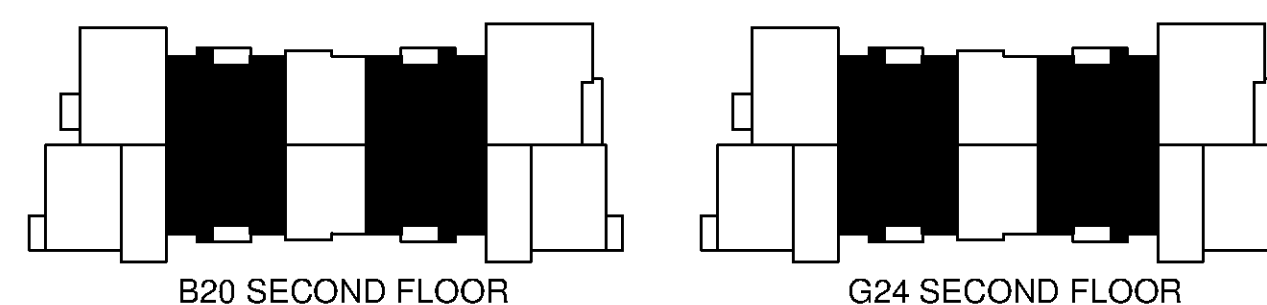

HVAC LEGEND AND SYMBOLS

⊖	THERMOSTAT
⊕	SWITCH
⊗	SUPPLY GRILLE
⊥	INTAKE / RETURN SIDEWALL LOUVER - TWO LOUVERS CONNECTED WITH SHEET GALVANIZED SHEET METAL COLLAR
RD	CEILING DIFFUSER WITH RADIATION DAMPER (SUPPLY DIFFUSERS)
UCD	RA THRU 1" CLEAR CUT
S-xxX CFM	DENOTES CEILING DIFFUSER SIZE AND CFM
R-xxX CFM	DENOTES CEILING GRILLE SIZE AND CFM
L-xxX CFM	DENOTES CEILING LOUVER SIZE AND CFM
—	FLEXIBLE DUCTWORK
10x10	RIGID FIBERGLASS DUCTWORK
⊕	4" DRYER BOX WITH DUCTWORK - SEE DETAIL 7 ON SHEET M-6.02
⊕	WALL MOUNTED BATHROOM FAN

A/C PLAN CODE NOTES

- PROVIDE RA THRU 24x12 WALL MOUNTED GRILLE ABOVE DOOR. GRILLE TO BE CONNECTED WITH GALVANIZED SHEET METAL COLLAR.
- EF-1 TO EXHAUST OUT THRU EXTERIOR WALL - SEE MANUFACTURERS RECOMMENDATIONS FOR INSTALLATION.
- 4" DRYER EXHAUST DUCT CONNECTED TO DRYER VENT BOX - SEE DETAIL 7 ON SHEET M-6.02. VENT THRU WALL - SEE MANUFACTURERS RECOMMENDATIONS FOR INSTALLATION. SEE PLAN VIEW FOR DUCT ROUTING. ALL VENT MUST BE 3 FT. FROM ANY OPENABLE WINDOW OR DOOR.
- WALL MOUNTED INTAKE LOUVER FOR DRYER MAKE-UP AIR TO BE MOUNTED ABOVE DOORS IN DRYER CLOSET. LOUVER TO BE CONNECTED WITH GALVANIZED SHEET METAL COLLAR. SEE DRAWING FOR GRILLE SIZE.
- REFRIGERANT LINES UP THRU INTERIOR WALL FROM UNDERGROUND TO FEED AHU AT GROUND AND UPPER LEVELS. COORDINATE EXACT LOCATION WITH PLUMBING LINES.
- BATHROOM OR DRYER EXHAUST WALL CAP - COORDINATE COLOR AND LOCATION WITH ARCHITECT. VENT MUST BE 3FT. FROM ANY OPENABLE WINDOW OR DOOR.
- THERMOSTAT MOUNTED AT 48" AFF. COORDINATE WIRING AND CONNECTION WITH MECHANICAL CONTRACTOR.
- UL RATED DUCTLESS RANGE HOOD.
- AHU IS TO BE LOCATED ON THE FLOOR. SEE DETAIL 3 ON SHEET M-6.02.