


VICINITY SITE MAP
SCALE: N.T.S.






WORK AREA

EXISTING SITE DRAINAGE PLAN
SCALE: 1"=20'-0"

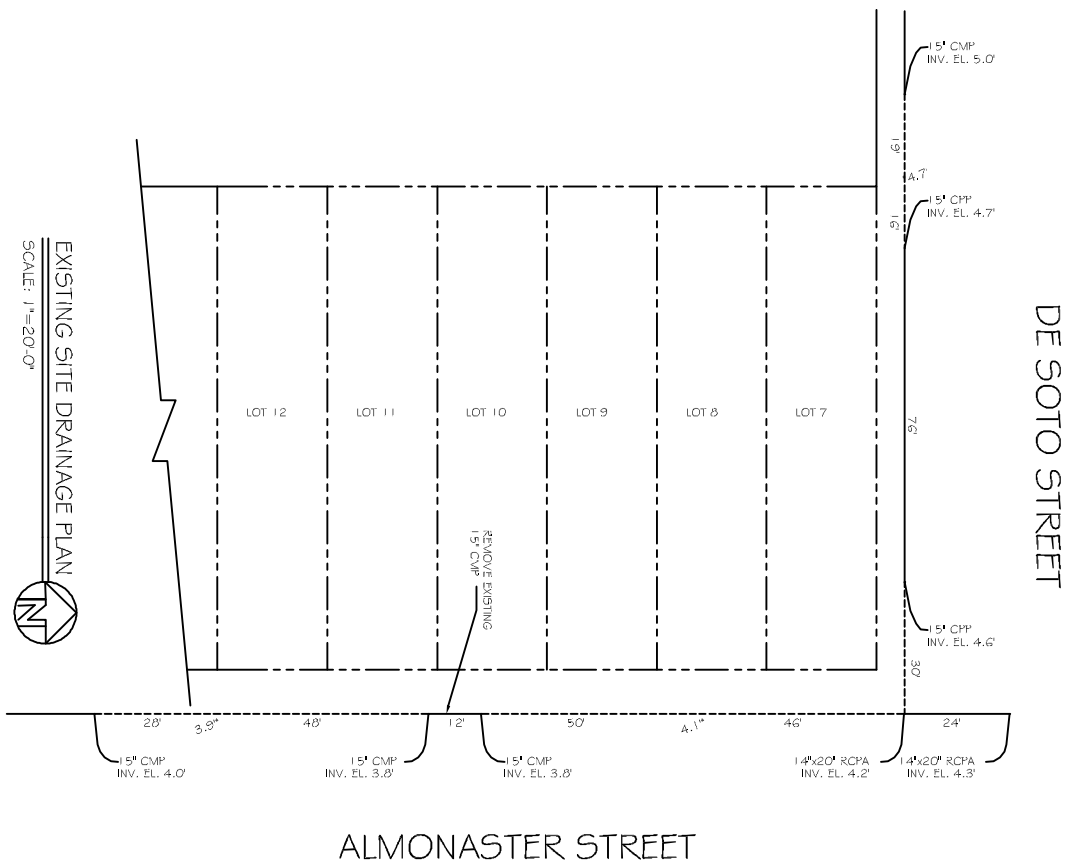

NEW SITE DRAINAGE PLAN
SCALE: 1"=20'-0"

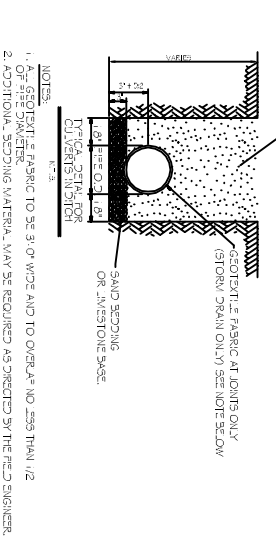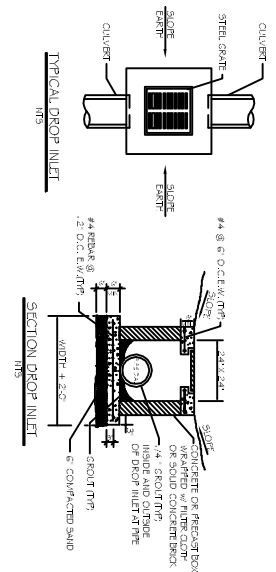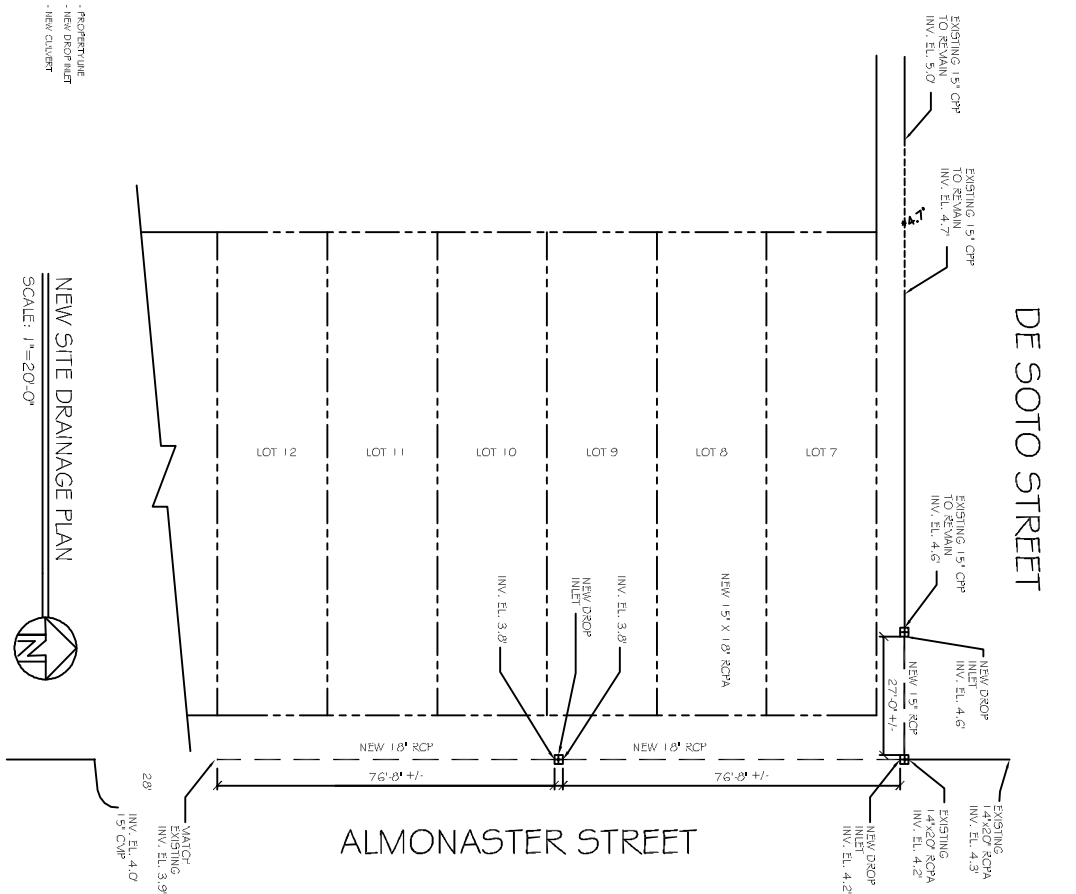

CONCRETE CURB IN CLASSES A, B, & C SHALL BE 12" HIGH AND 12" WIDE. PROVIDE CURB TO MATCH EXISTING OR AS SHOWN. PROVIDE 1" SAND BEDDING UNDER CURB AND 4" SAND BEDDING UNDER INLET.

NOTES:
1. PROVIDE FABRIC FILTER AT JOINTS ONLY (STORM DRAIN ONLY) SEE NOTE BELOW.
2. ADDITIONAL BEDDING MATERIAL MAY BE REQUIRED AS DIRECTED BY THE P.E. ENGINEER.

LEGEND
- PROPOSED
- EXISTING
- NEW CURB

REVISIONS	
#	DESCRIPTION

CHRIS DUPLY DRAINAGE PLAN
56387 ALMONASTER STREET
SUDELL, LOUISIANA 70458

JOB No: DATE: 08-13-13

DRAWN BY: CKD CHECKED BY: CKD

DAMMON ENGINEERING, INC.
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