

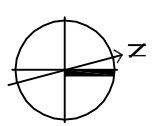


2 NEW ROOF FRAMING PLAN
SCALE: 3/16" = 1'-0"

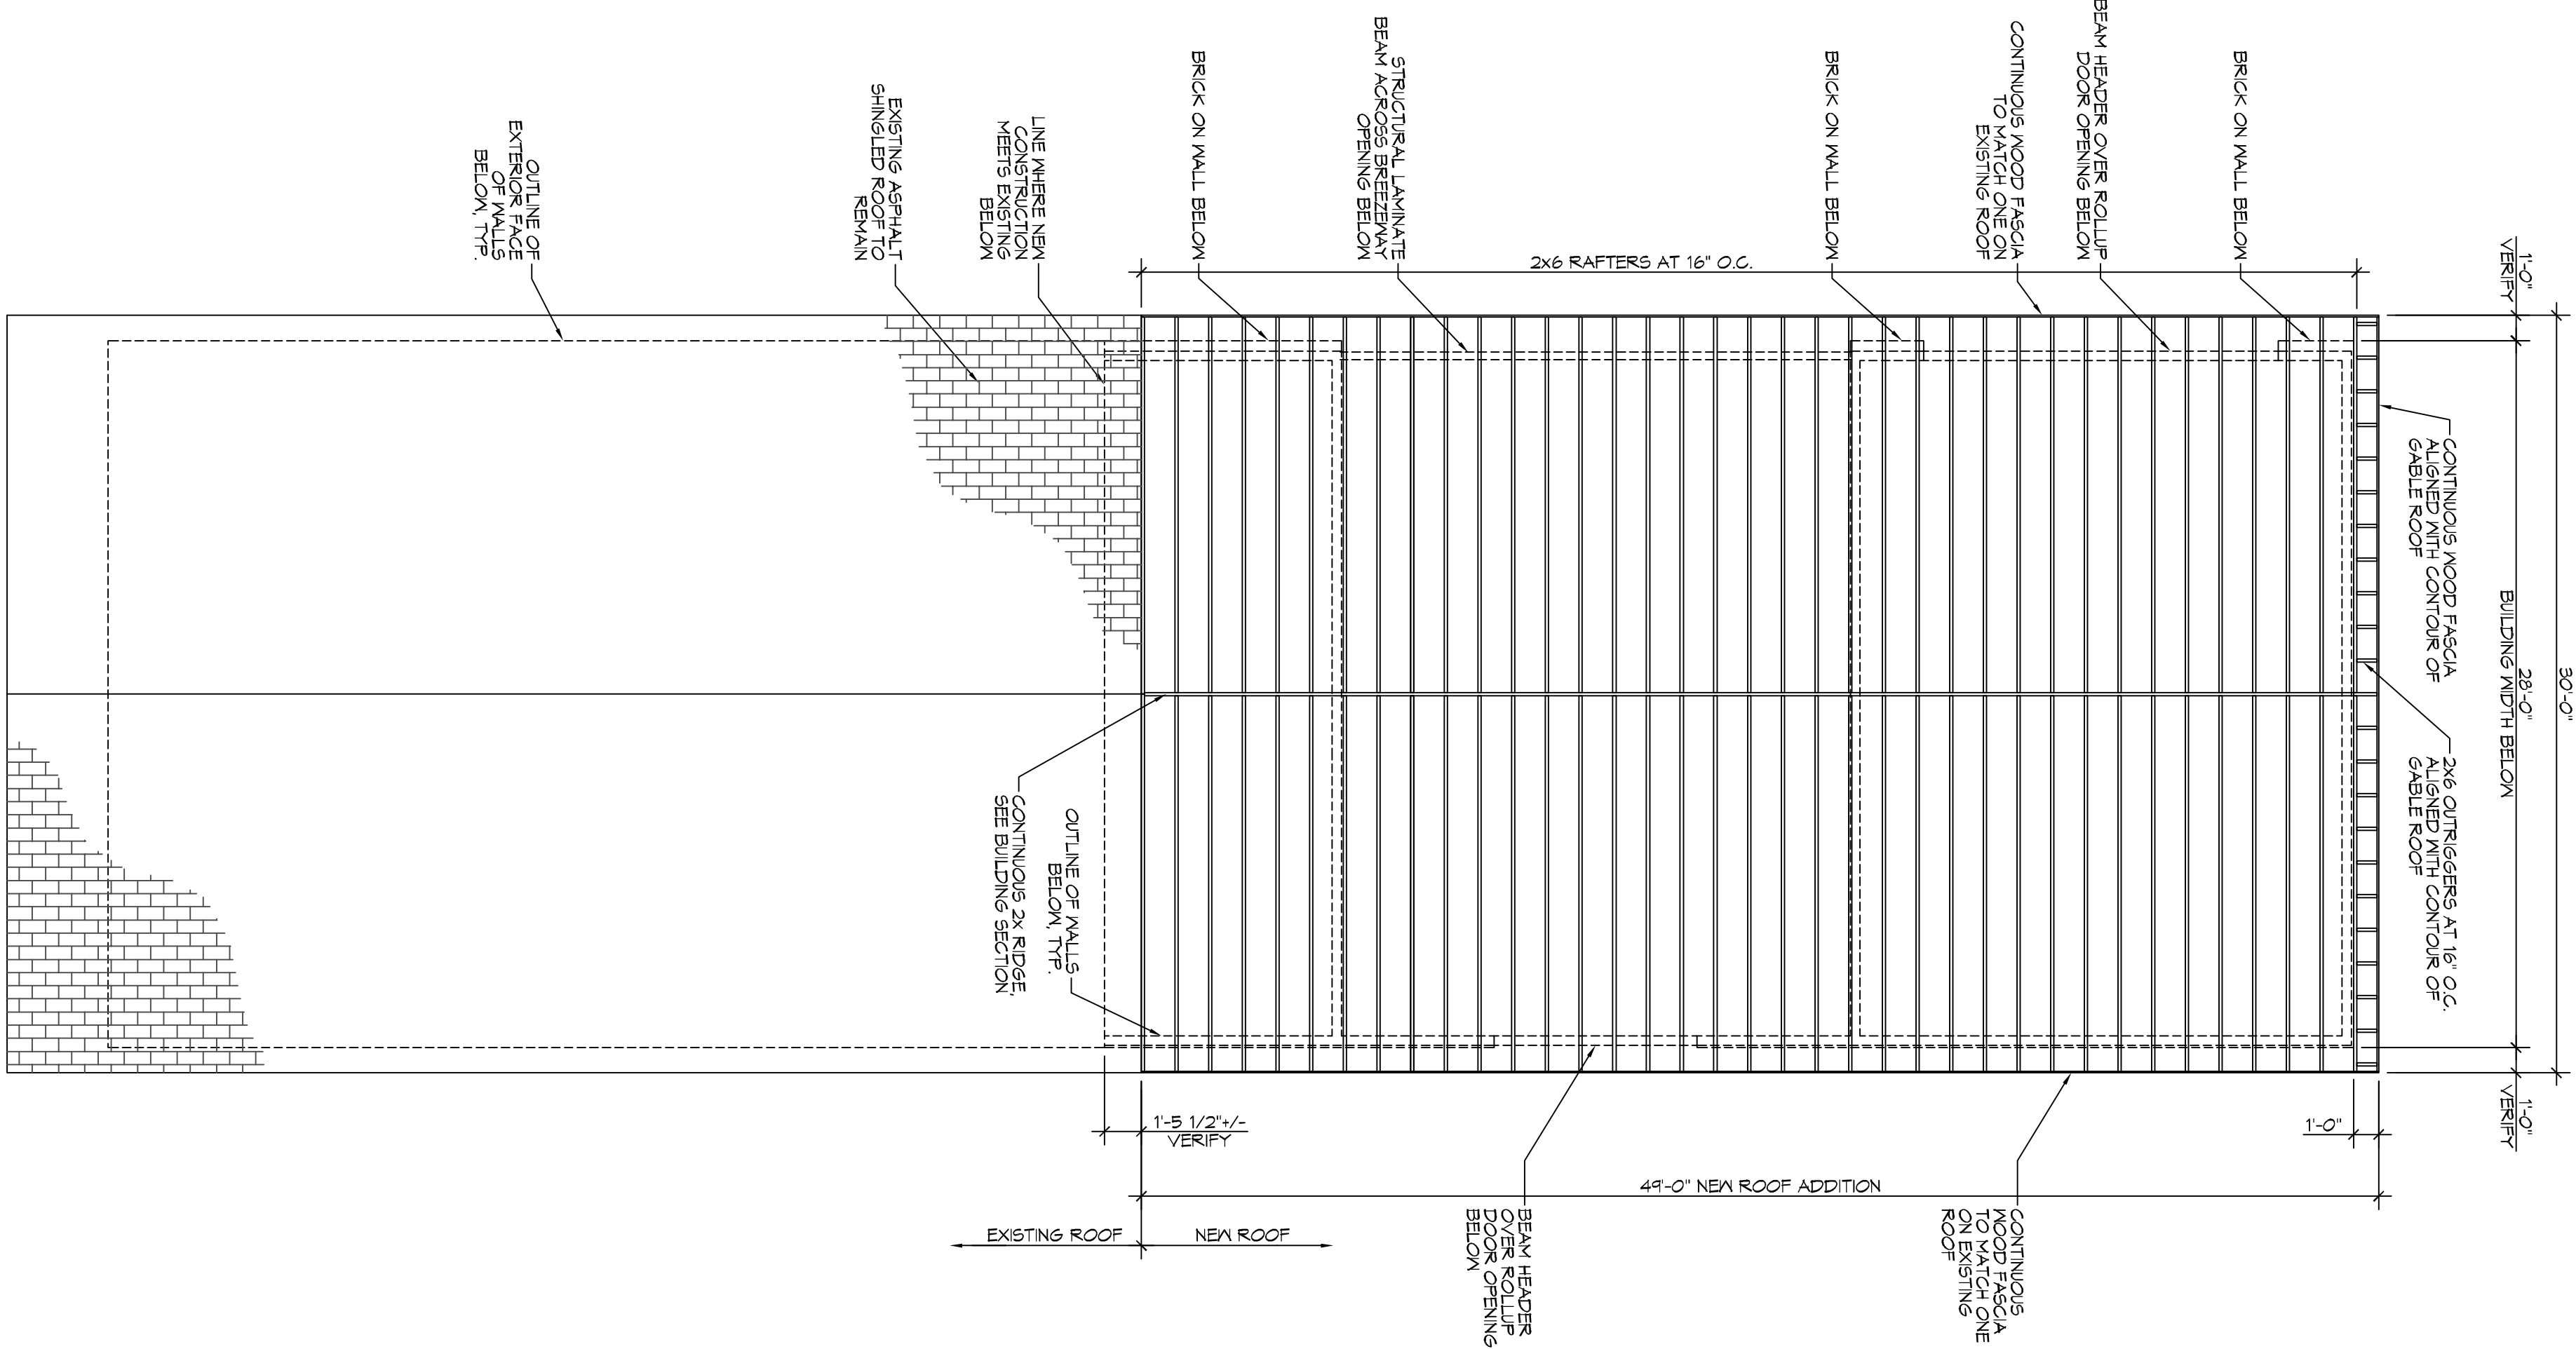

1 NEW ROOF PLAN
SCALE: 3/16" = 1'-0"

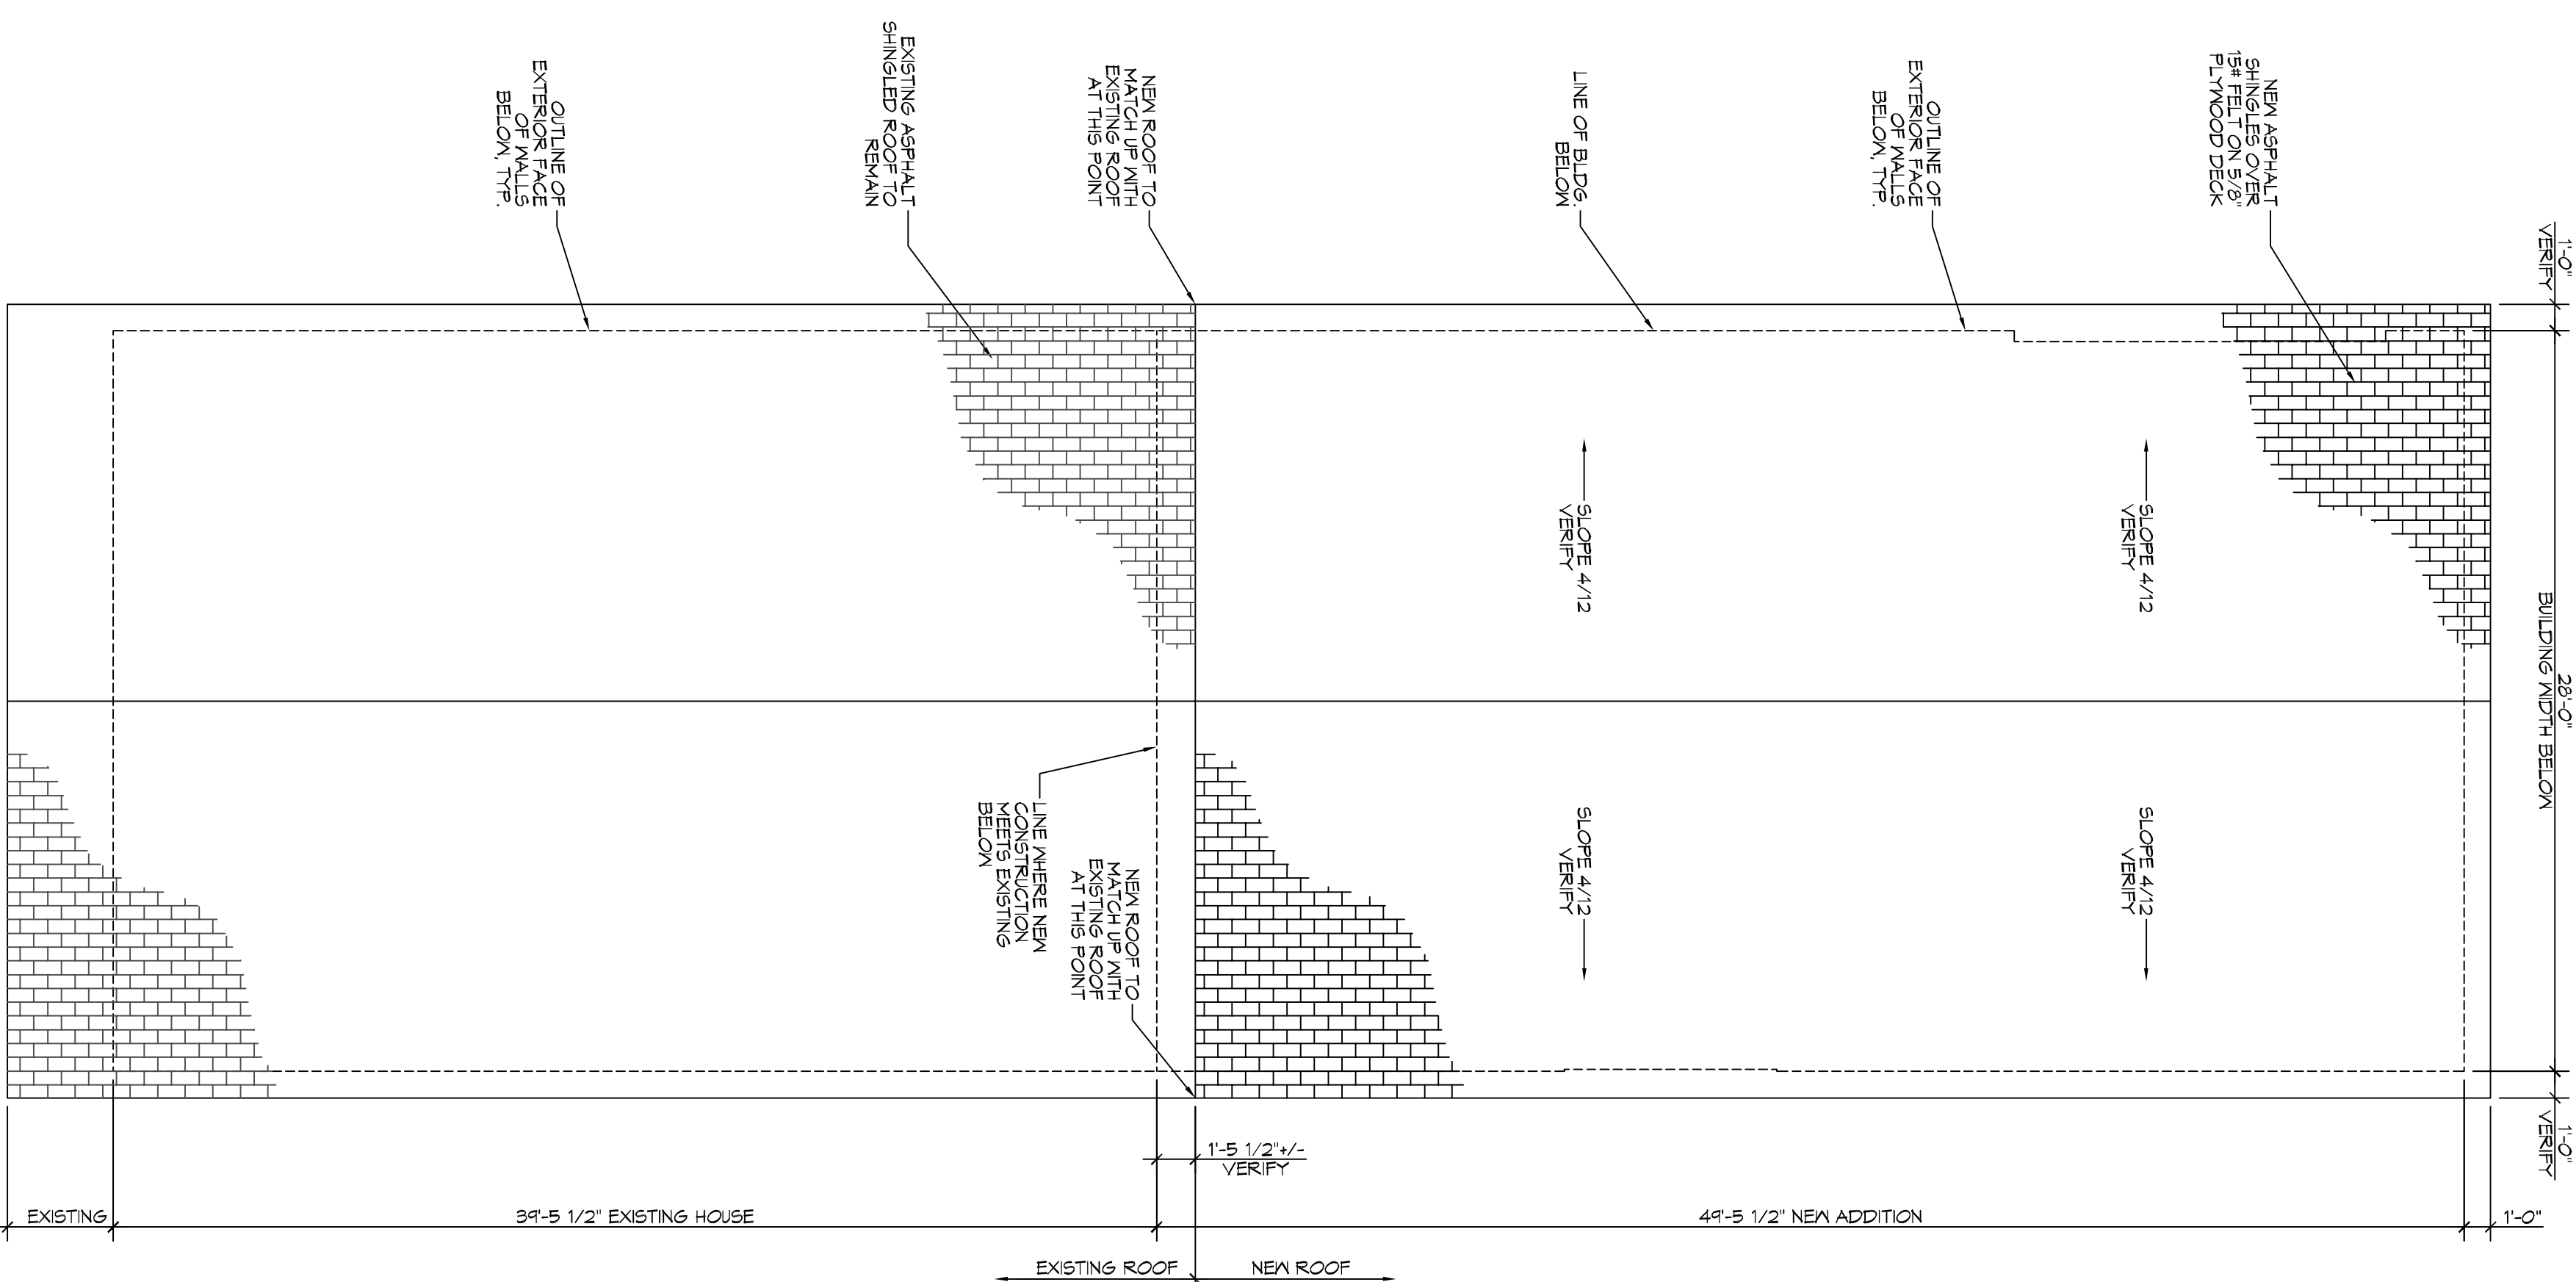

ROOF FRAMING NOTES

1. ALL DIMENSIONS ARE TO CENTER OF BEAM, RAFTER, TRUSS, OR JOIST UNLESS OTHERWISE NOTED.
2. RAFTER, TRUSS, OR JOIST BEARING ELEVATION IS HEIGHT ABOVE SLEEFLOOR OR FLOOR SLAB. SEE WALL SECTIONS FOR CLARIFICATION.
3. BRICK ON WALL BEARING AND PENETRATIONS IN PARTS ROOSTS INTO PLACE BEFORE ROOF DECKING IS INSTALLED.
4. ROOF DECK SHALL BE 5/8" EXPOSURE 1 PLYWOOD MANUFACTURER.
5. HOLD ROOF DECKING PANELS APART AS RECOMMENDED BY DECKING MANUFACTURER.
6. HOLD ROOF DECK PANELS AWAY FROM ITEMS PENETRATING ROOF DECK AS RECOMMENDED BY ROOF DECK MANUFACTURER TO ALLOW PROPER DRAINAGE ON ROOF.
7. RAFTERS AND TRUSSES SHALL BE ONE SIZE LARGER THAN RAFTERS OR TRUSSES, UNLESS NOTED OTHERWISE. ANY HIP OR VALLEY RAFTER OVER 28' LONG SHALL BE LAMINATED VENEER LUMBER.



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REVISIONS		DATE
#	DESCRIPTION	

PRELIMINARY NOT FOR CONSTRUCTION

RENOVATIONS AND ADDITIONS TO
TIM MARLOWE
554 OLD SPANISH TRAIL
PO BOX 10003
METARIE, LA 70003

JOB No: [###] DATE: 10-26-16
DRAWN BY: JTL CHECKED BY: KD

SHEET TITLE:
NEW ROOF PLAN &
ROOF FRAMING PLAN

DRAWING NUMBER:

A102

SHEET NO.:

6 OF 7