



4 DECK/PATIO ROOF FRAMING PLAN
SCALE: 1/4" = 1'-0"

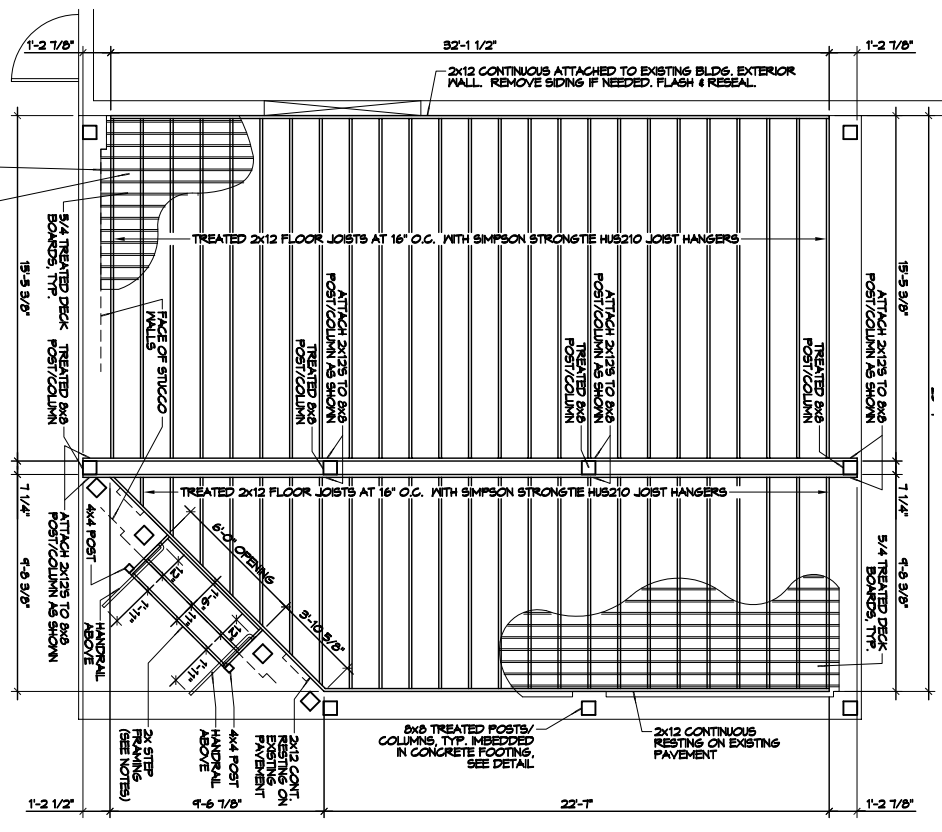


3 PATIO DECK FRAMING PLAN
SCALE: 1/4" = 1'-0"

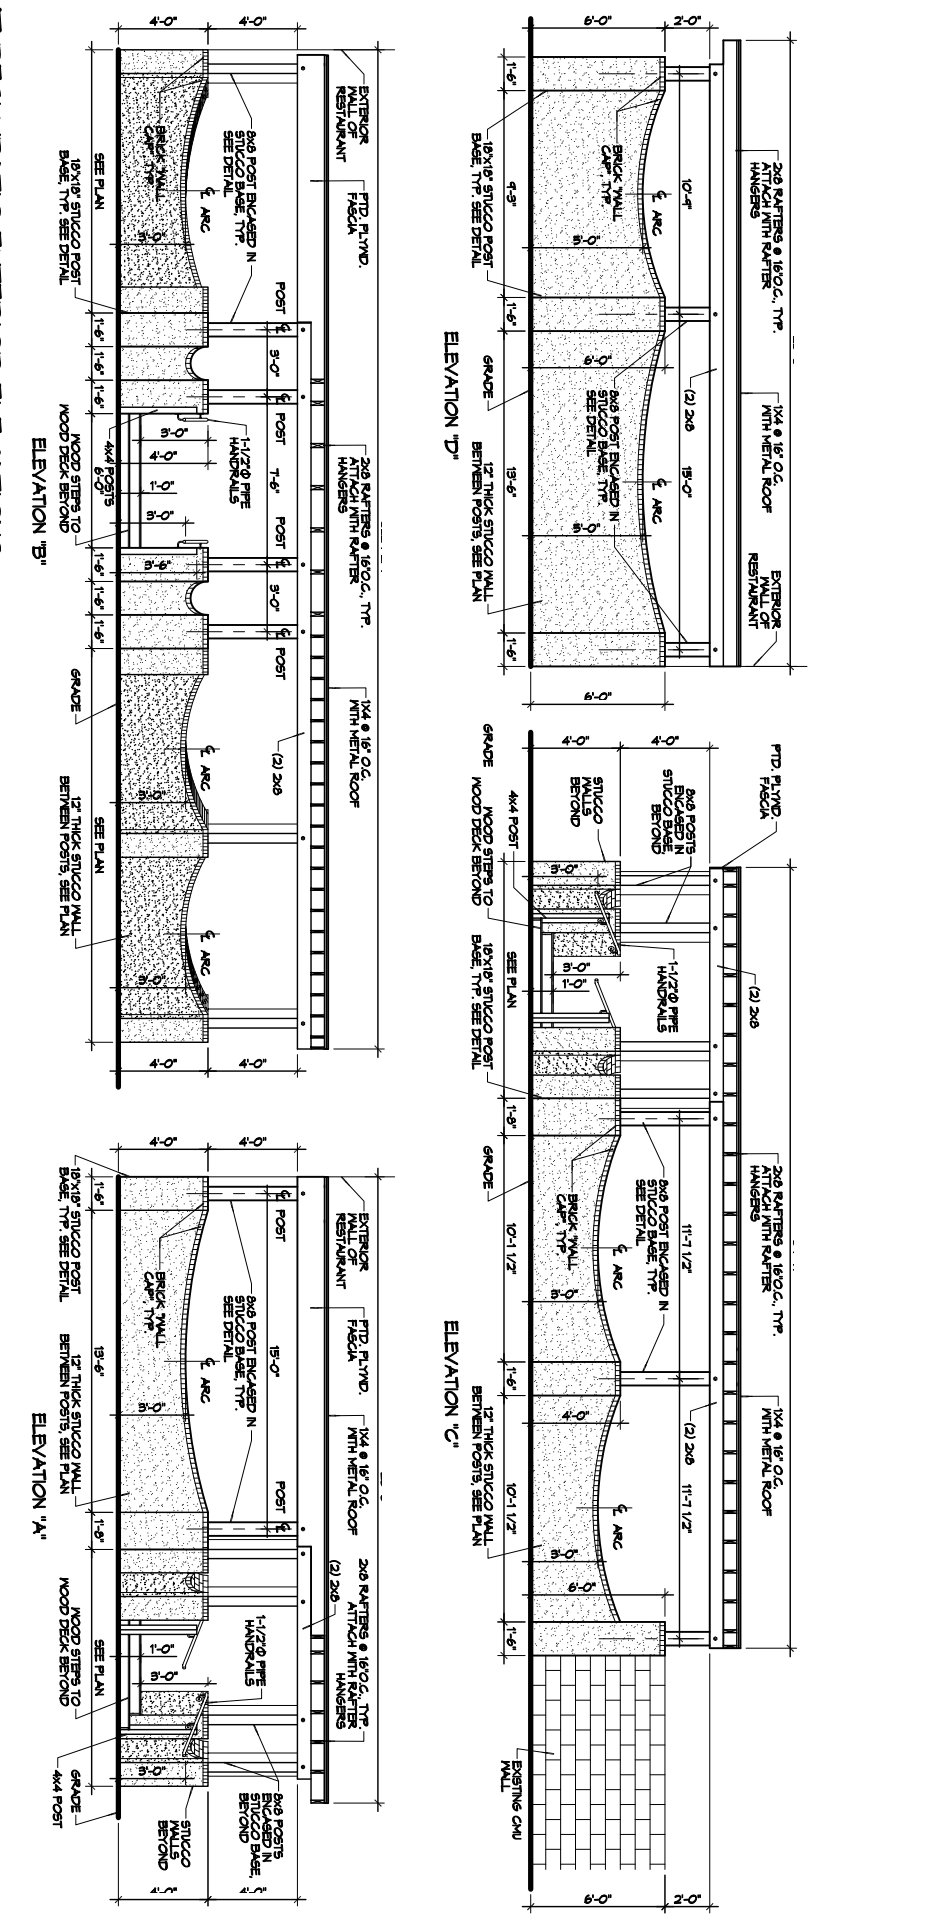


5 DECK/PATIO EXTERIOR ELEVATIONS
SCALE: 1/4" = 1'-0"

THE CONSTRUCTION FOR SAID RESURFACE WHERE BAS VIBRO SANDING (100 MESH PER HOUR) IS DESIGNED IN ACCORDANCE WITH AMERICAN FOREST AND PAPER ASSOCIATION (AF&PA) WOOD FRAME CONSTRUCTION MANUAL FOR ONE AND TWO FAMILY DWELLINGS (MFCM) 2001 EDITION, AS WELL AS THE INTERNATIONAL RESIDENTIAL CODE (IRC) 2012 EDITION CHAPTER 4, ALL NETWORK SHALL BE FURCANE STRIPPED.

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2 DECK/PATIO LINTEL SUPPORT PLAN
SCALE: 1/4" = 1'-0"

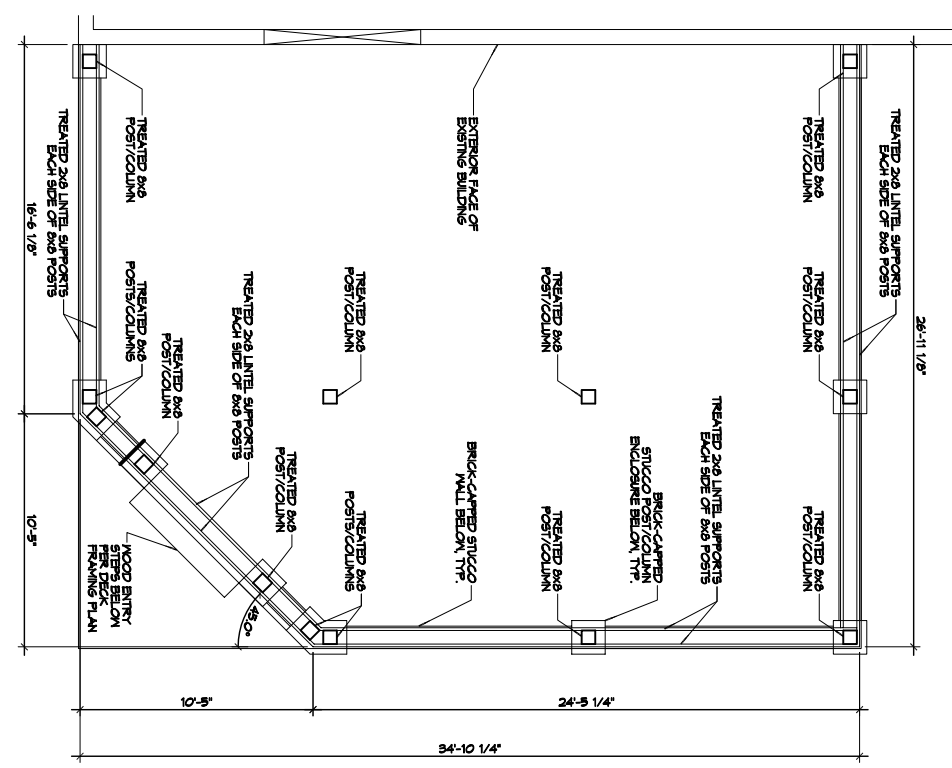

1 DECK/PATIO MALL & POST LAYOUT
SCALE: 1/4" = 1'-0"

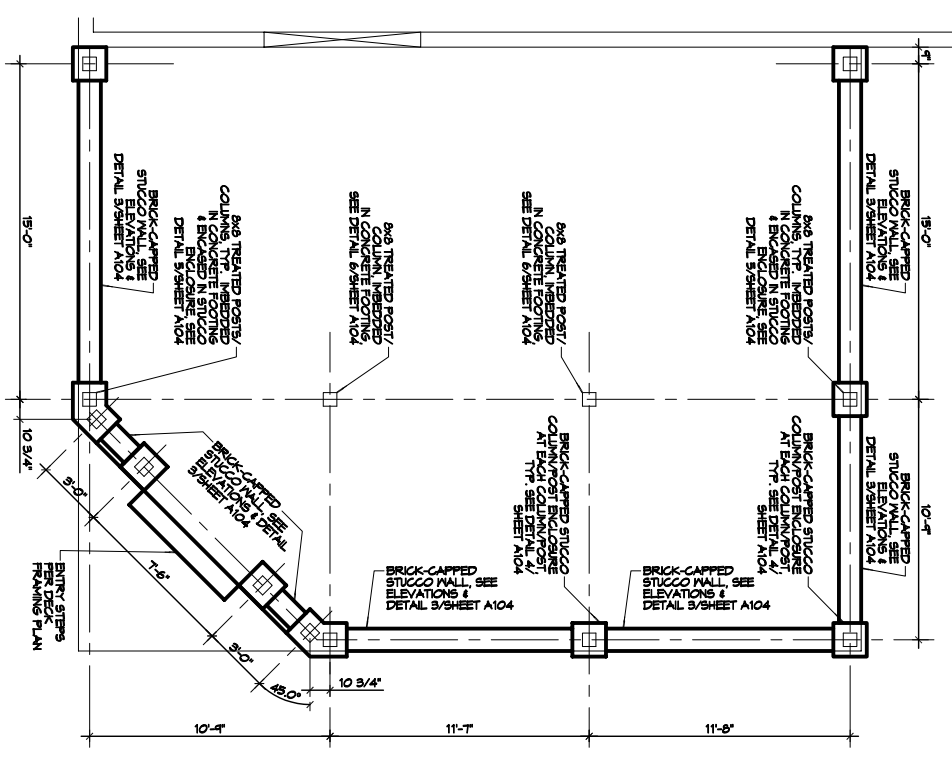REVISIONS		DATE
#	DESCRIPTION	

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A103

RESTAURANT

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JOB No: 2242 DATE: 12-09-15

SHEET TITLE: REAR PATIO/DECK & ROOF TRUSS/FRAMING PLANS & ELEVATIONS

DRAWING NUMBER: A103

SHEET NO: 1 of 1