
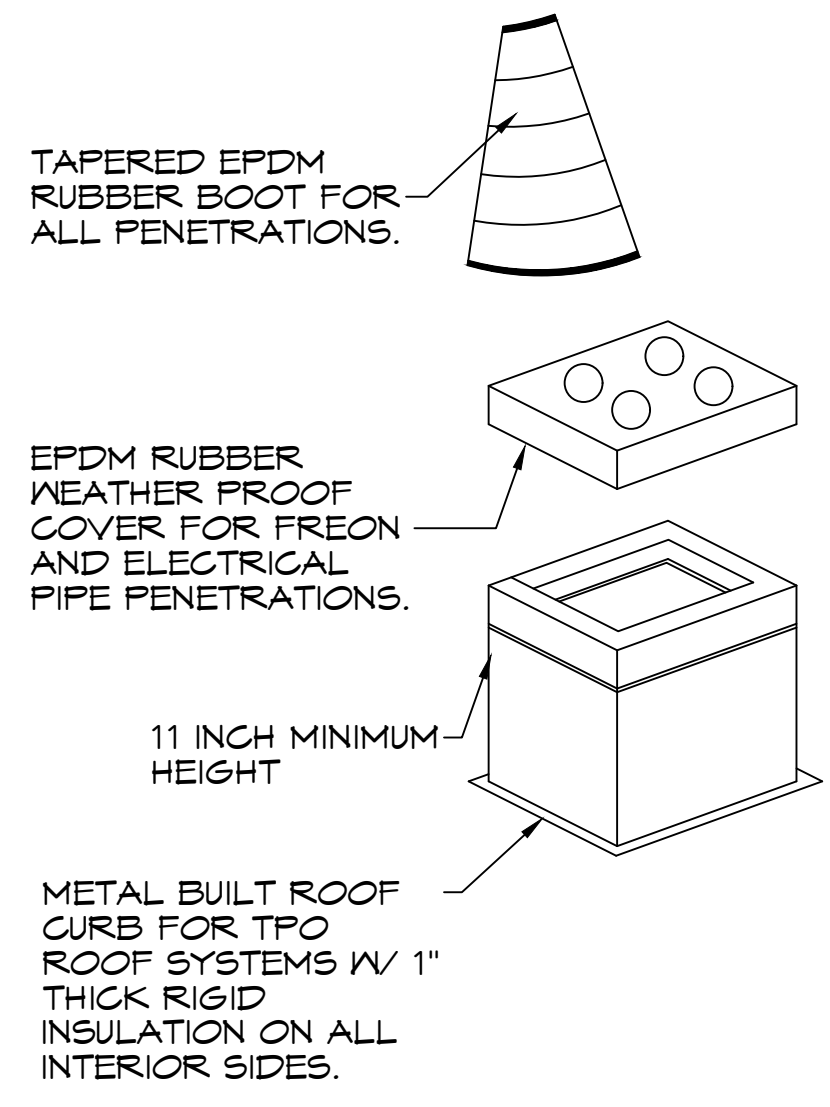
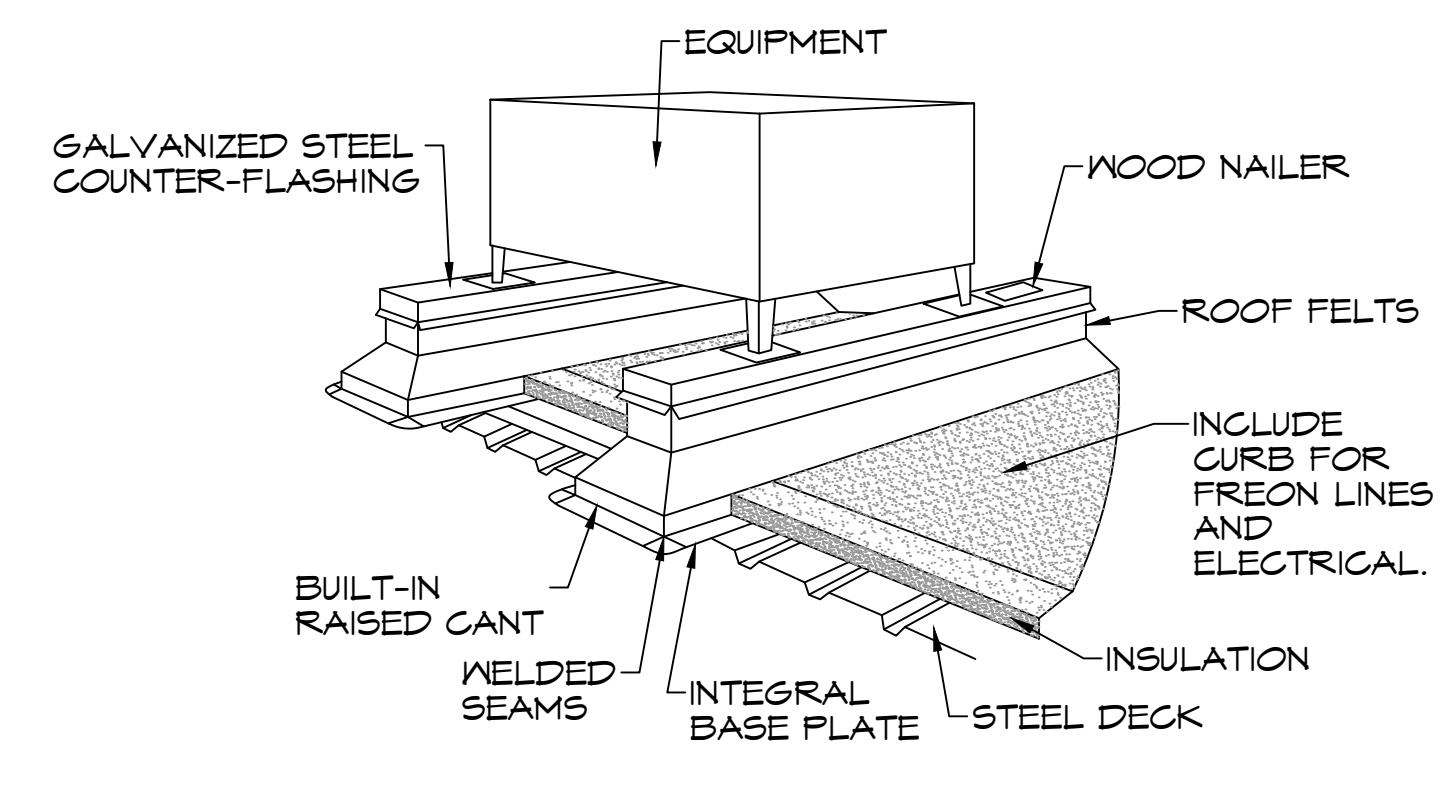


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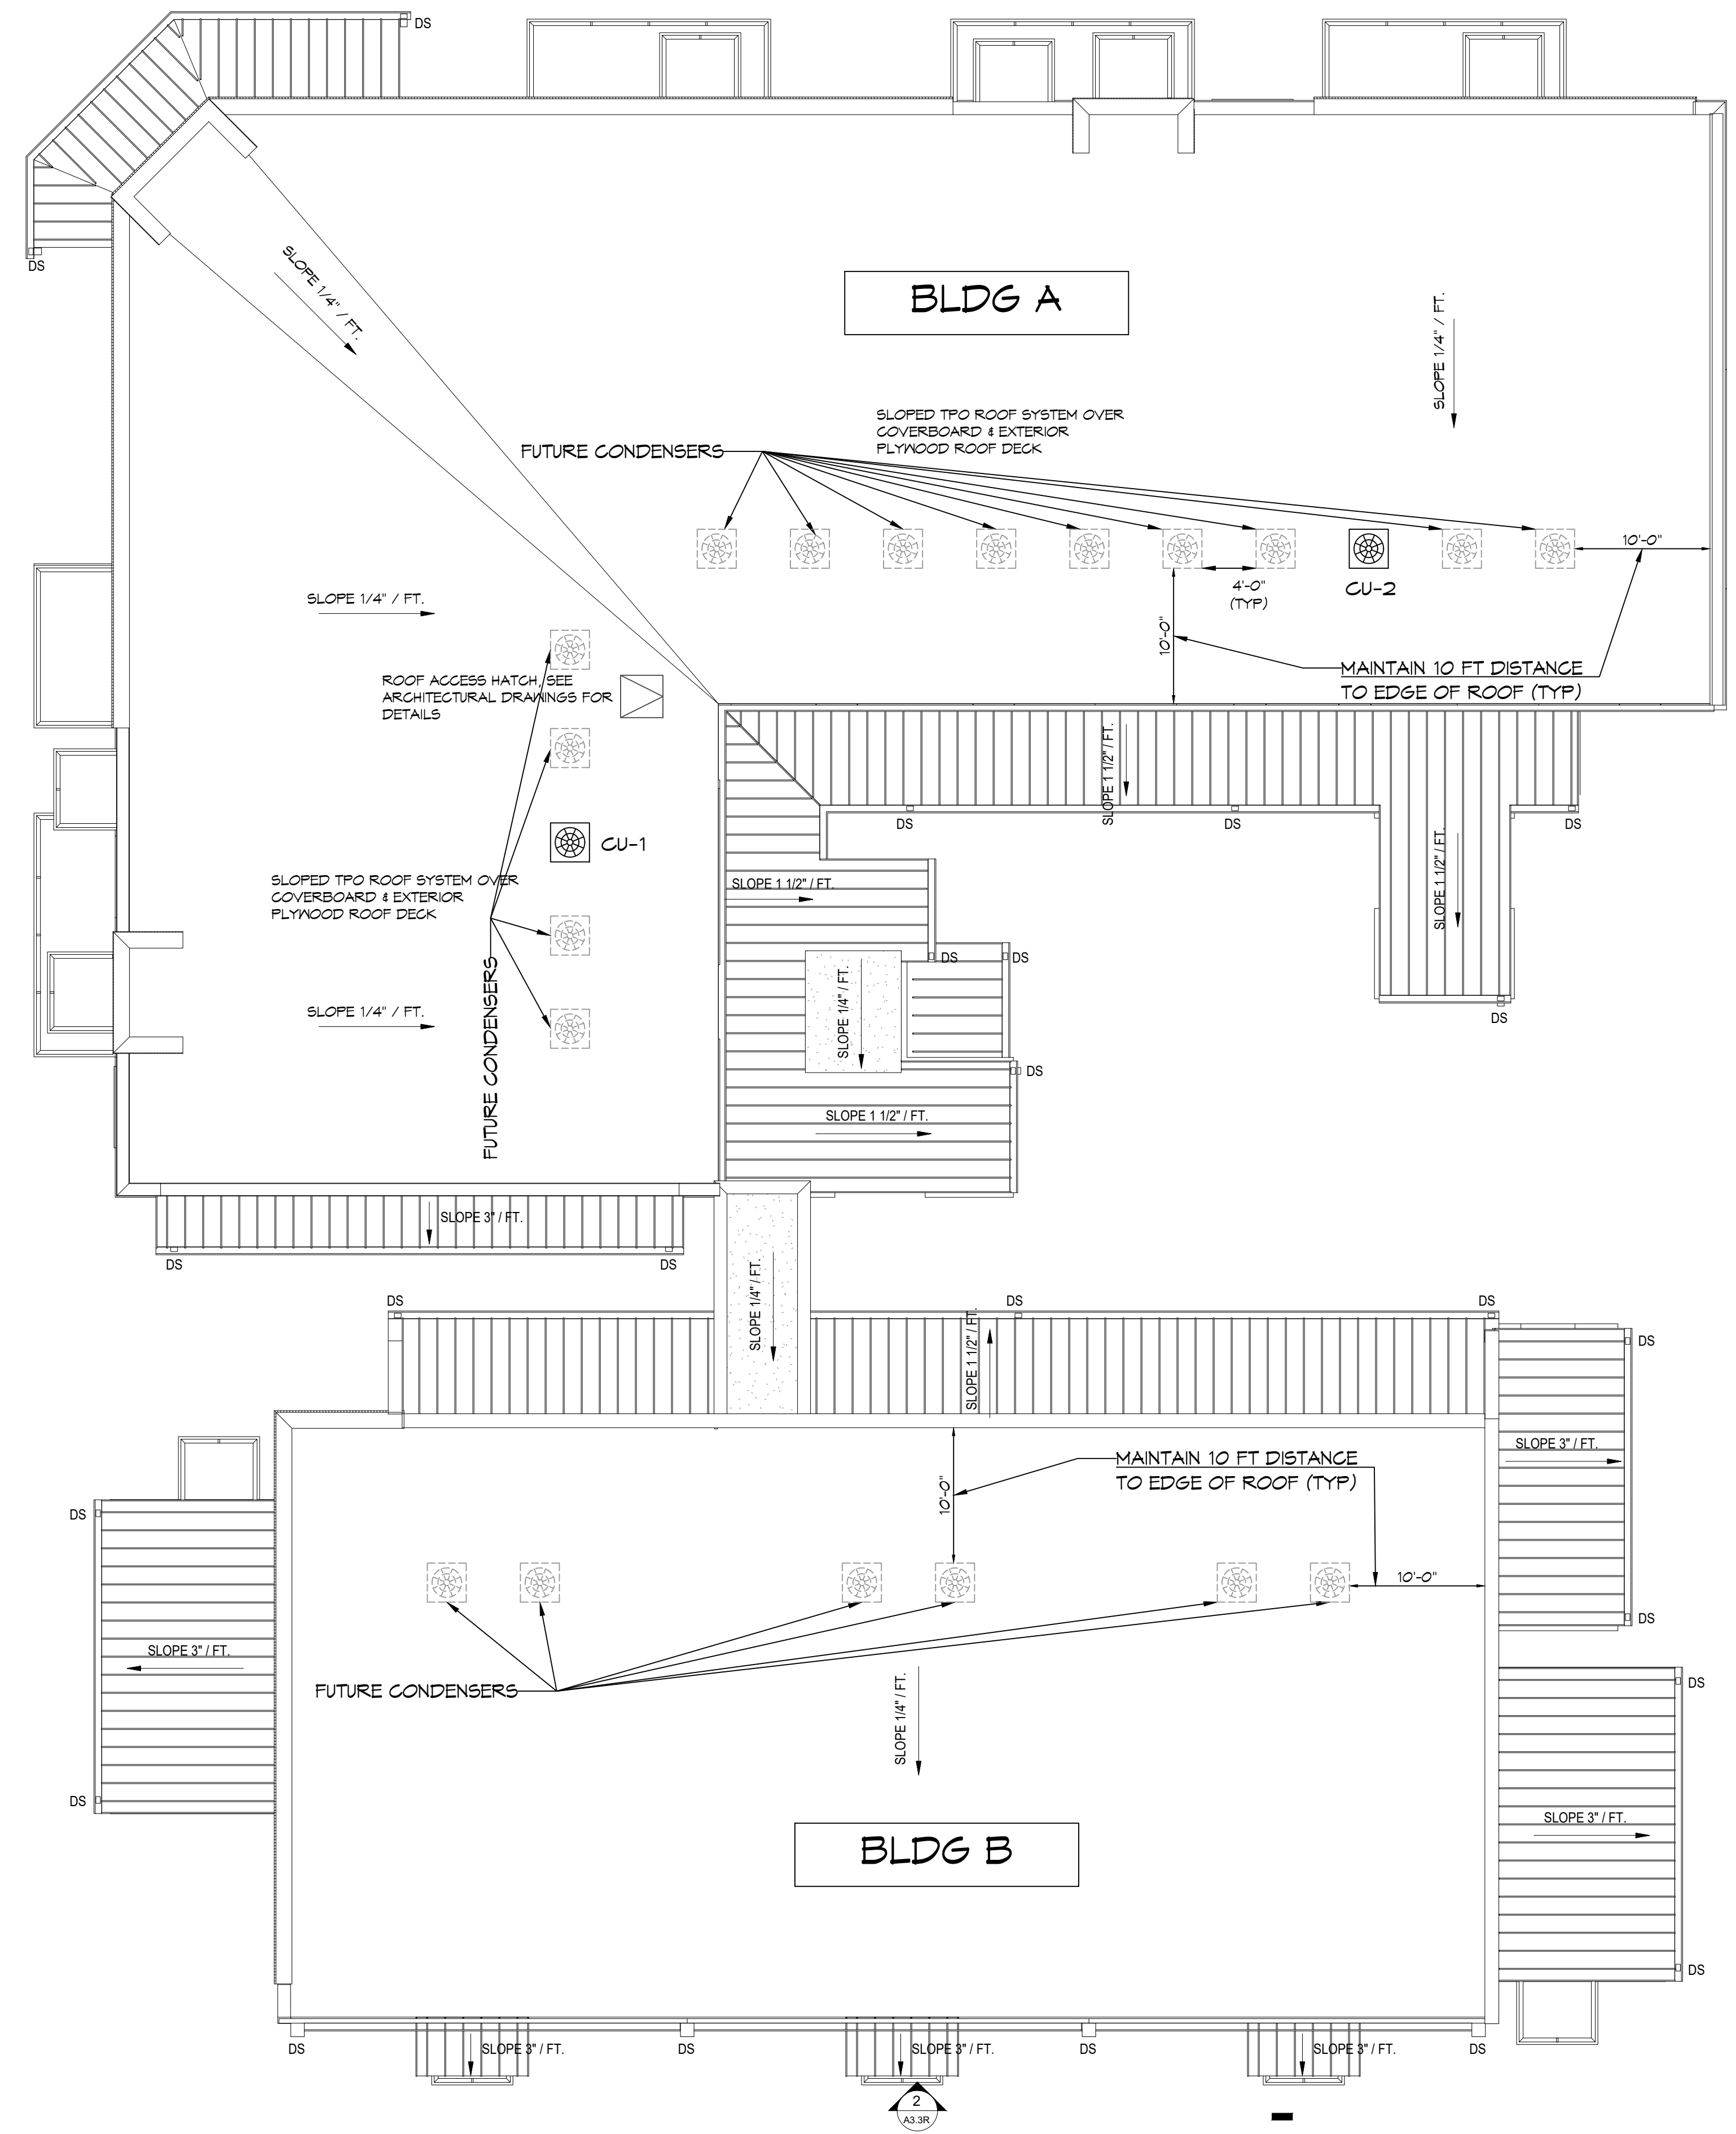
B ROOF CURB

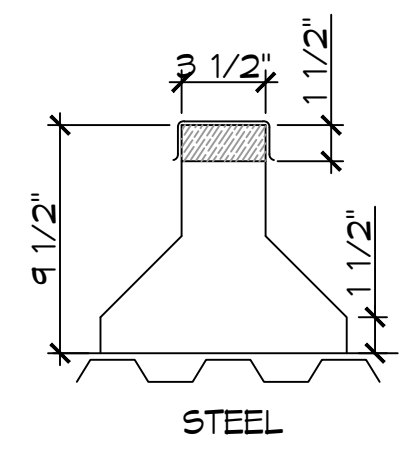

A CONDENSER CANT

TYPICAL DETAILS
SCALE: N.T.S.

MECHANICAL ROOF PLAN
SCALE: 1/8" = 1'-0"



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#	DESCRIPTION	DATE

SEAL:

SHELL BUILDING
S Q U A R E S
OFFICE AND RETAIL MIXED USE AND
RESIDENTIAL CONDOMINIUMS
 BOSTON STREET AND VERMONT STREET,
 COVINGTON, LA 70438
 JOB No: 2442 DATE: 3/7/2024
 DRAWN BY: BAK1 CHECKED BY: dpc1

SHEET TITLE:
MECHANICAL ROOF PLAN
 DRAWING NUMBER:
M102