



**2** EXTERIOR ELEVATION  
SCALE: 3/16" = 1'-0"

SOUTH

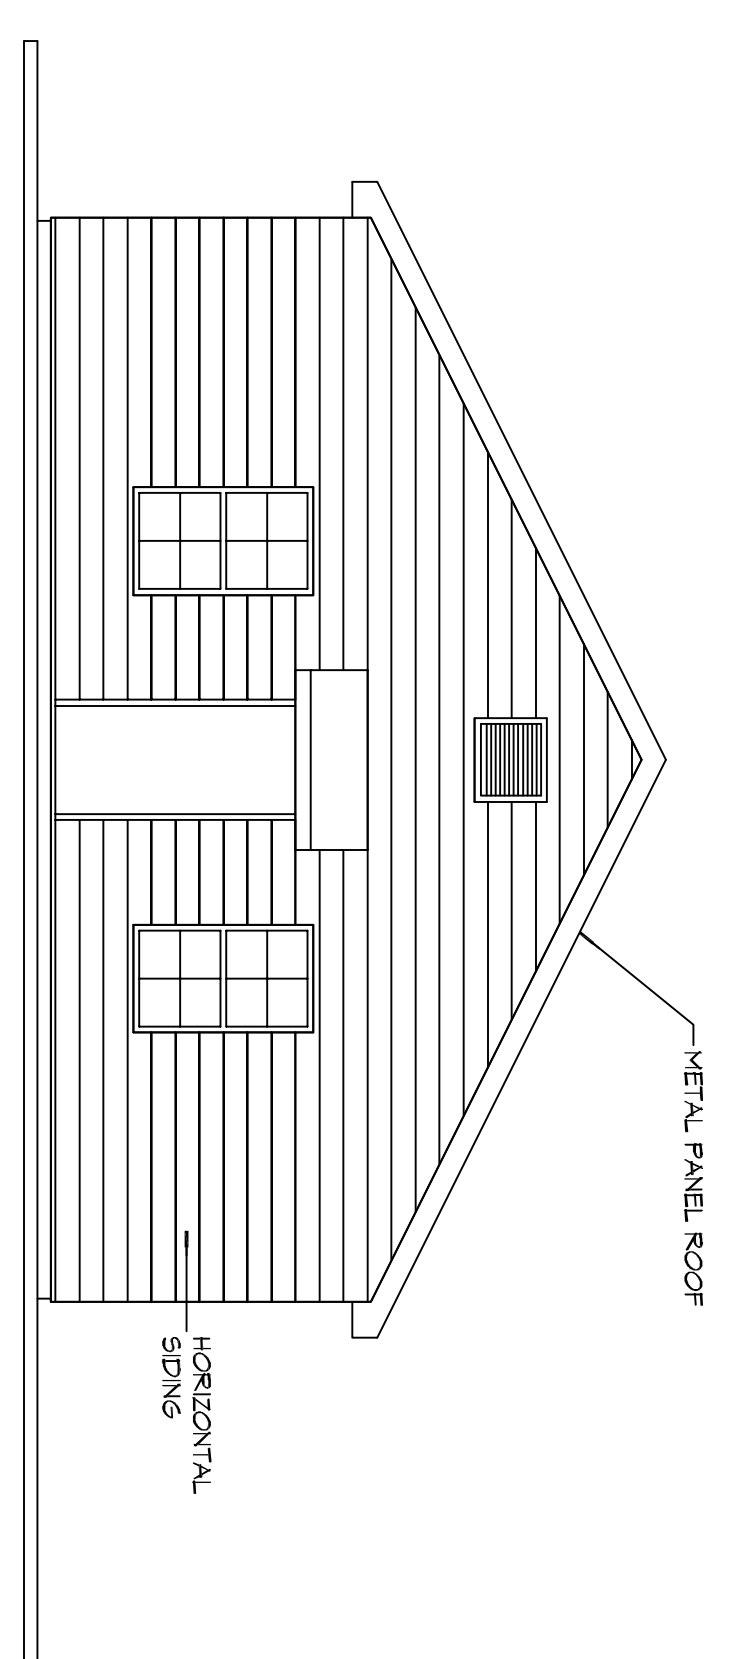


**3** EXTERIOR ELEVATION  
SCALE: 3/16" = 1'-0"

WEST

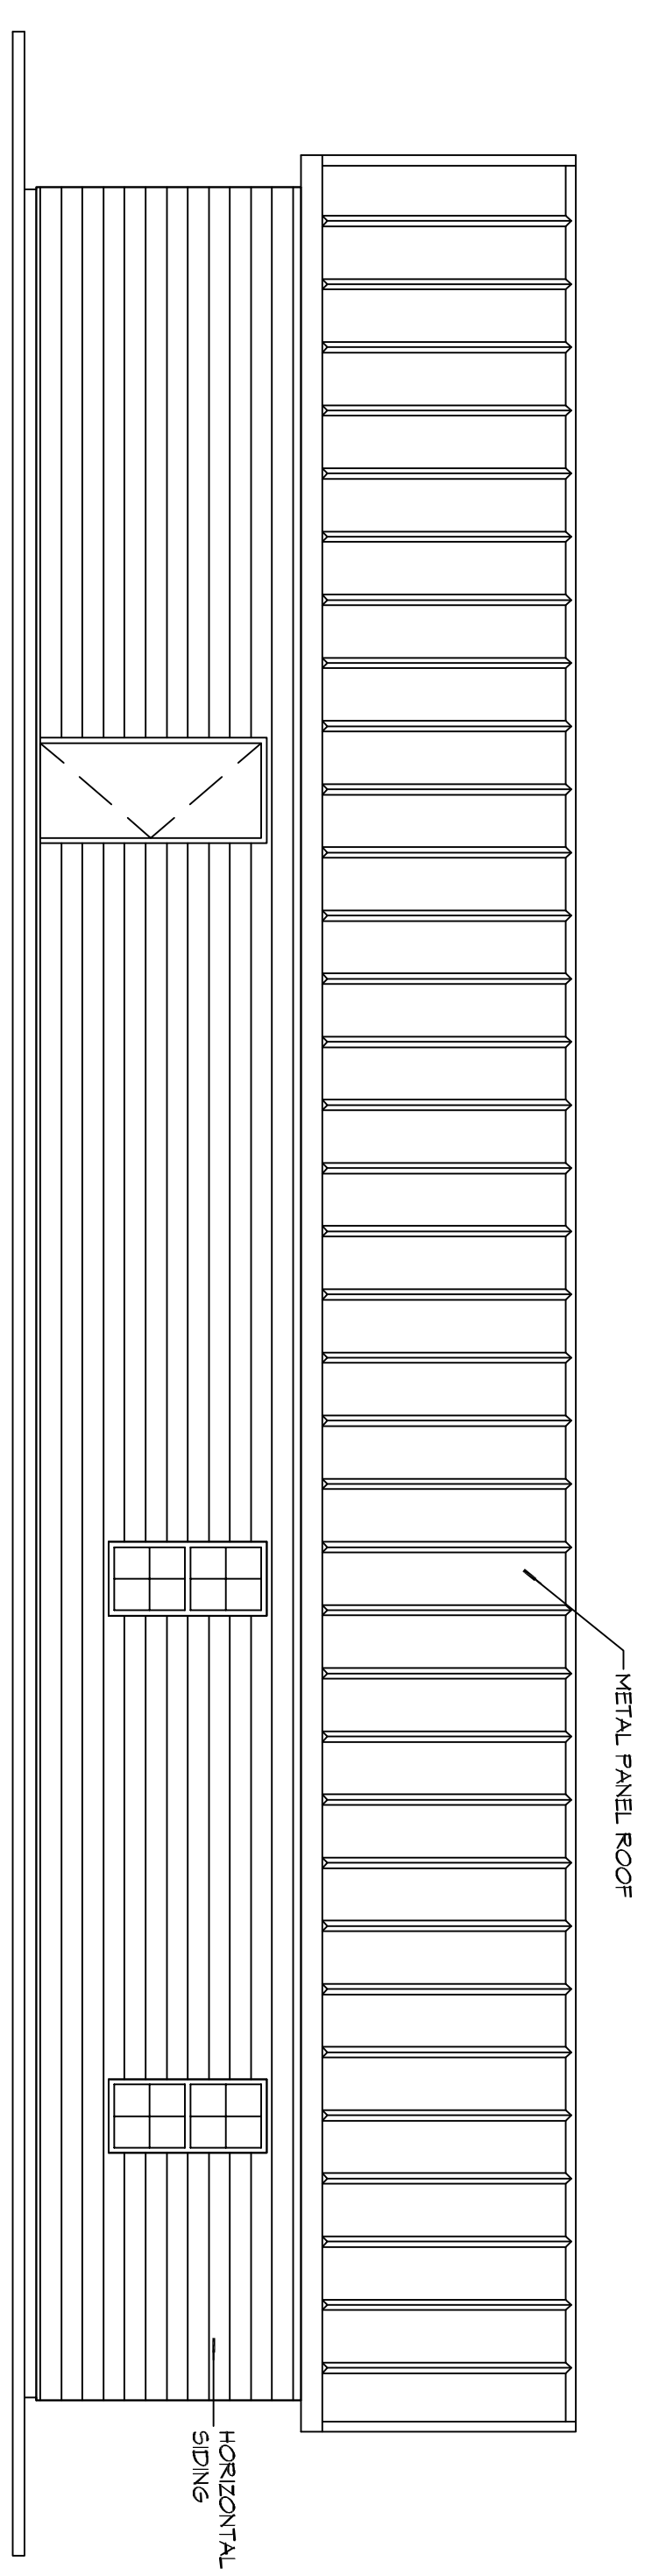

**4** EXTERIOR ELEVATION  
SCALE: 3/16" = 1'-0"

NORTH

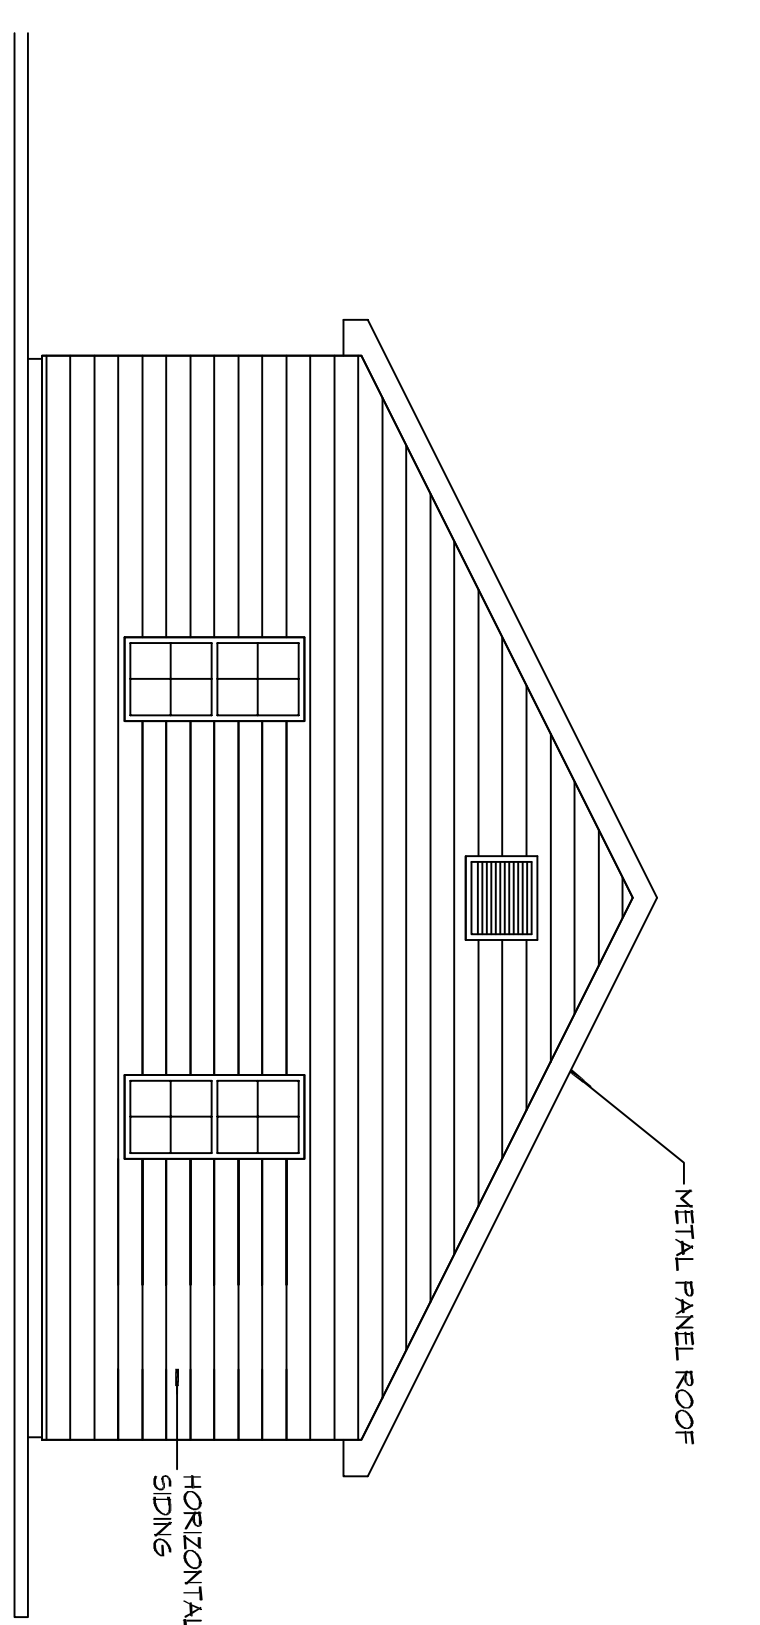

**5** EXTERIOR ELEVATION  
SCALE: 3/16" = 1'-0"

EAST

**DAMMON**  
ENGINEERING, INC.  
LOUISIANA & MISSISSIPPI

Chief Engineer: Brian Mstich, PE  
554 Old Spanish Trail  
Slidell, LA 70458  
www.dammonengineering.com  
info@dammonengineering.com  
PH: 985.649.5832

REVISIONS		
#	DESCRIPTION	DATE

**PRO MULTIS  
LACOMBE CHAPEL**

2354  
12-19-18  
CKD  
CKD

SHEET TITLE:  
EXTERIOR ELEVATIONS

DRAWING NUMBER:

**A201**

SHEET NO. 3 OF 3

The above drawings, specifications, designs and all engineering representations hereby are prepared by Dammon Engineering, Inc. and are the property of Dammon Engineering, Inc. and shall remain the property of Dammon Engineering, Inc. and shall not be used for any other project without the written consent of Dammon Engineering. If you are not a client of Dammon Engineering, you are not to be bound by these drawings or specifications. If you are a client of Dammon Engineering, you are to be bound by these drawings or specifications. If you are not a client of Dammon Engineering, you are not to be bound by these drawings or specifications. If you are a client of Dammon Engineering, you are to be bound by these drawings or specifications.