



FLOOR GRATING SHALL BE LIGHT DUTY WELDED
STL. "SERRATED" BAR GRATING.
MAXIMUM SPAN SHALL BE 6 FOOT

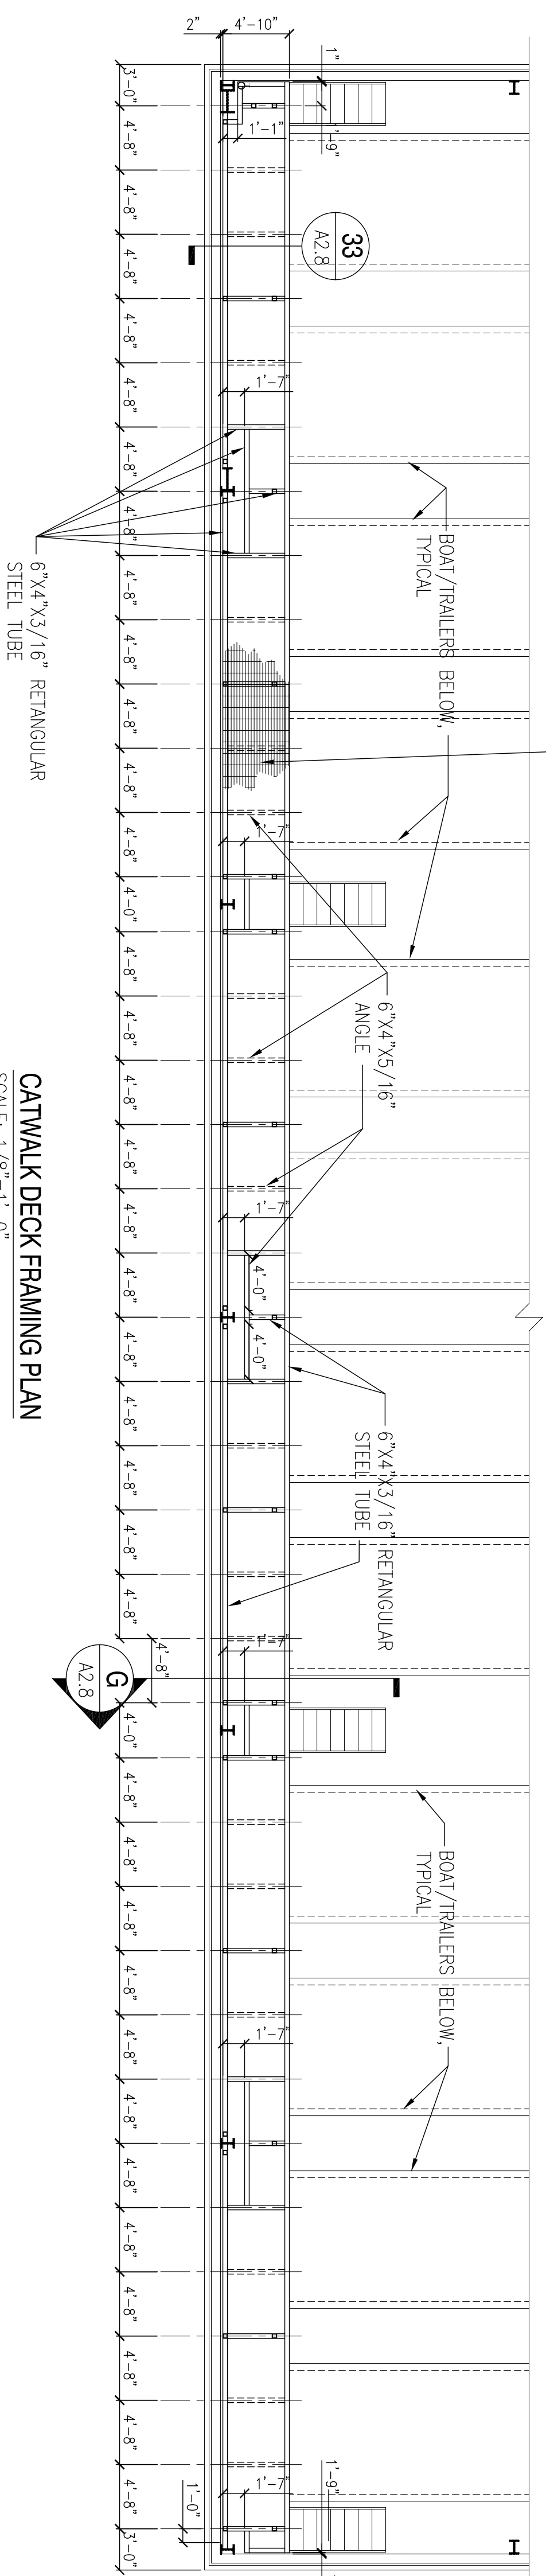


CATWALK DECK FRAMING PLAN
SCALE: 1/8"=1'-0"

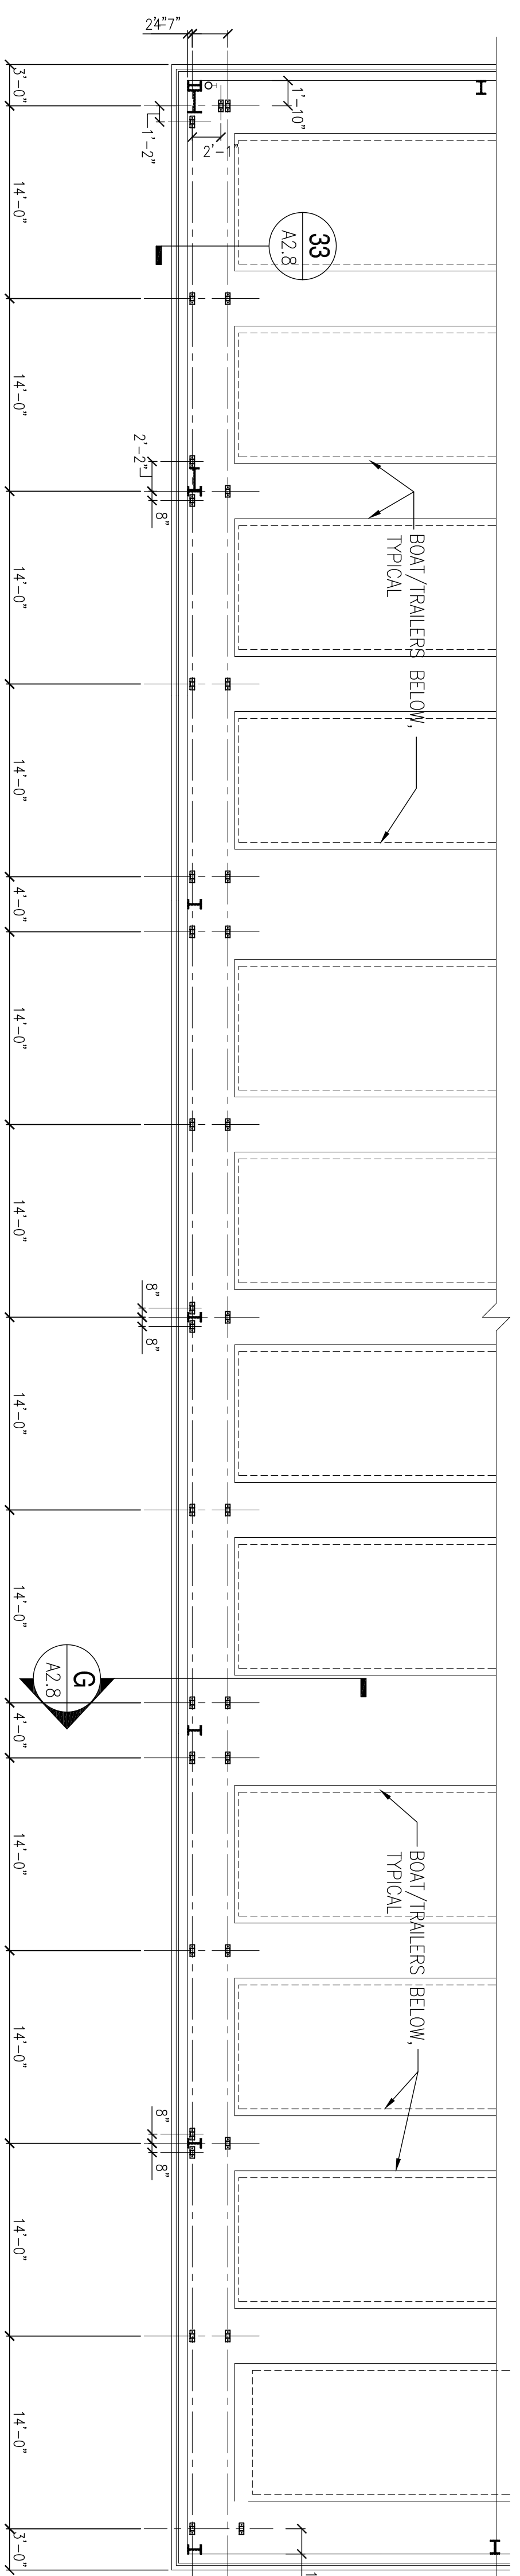

CATWALK COLUMN LAYOUT
SCALE: 1/8"=1'-0"

SYM	DESCRIPTION	DATE	APPR

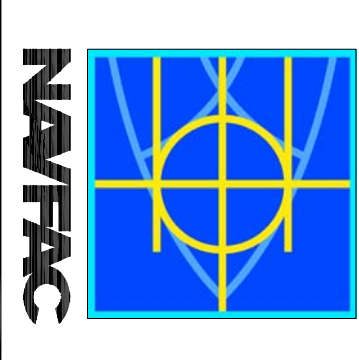

DAMMON
ENGINEERING, INC.
REGISTERED PROFESSIONAL ENGINEER
STATE OF MISSISSIPPI
NO. 19, 2008
1000 N. WILSON
SUITE 200
DAMMON, LA 70001
(985) 649-8312

DES. R. WATSE DRAW. J. LOOUE
REVIEWED BY: R. WATSE
PUNJIK, T. ARBIB
CHECKED BY: P. DAMMON
CHIEF ENGINEER, P. DAMMON

DEPARTMENT OF THE NAVY
NAVAL FACILITIES ENGINEERING COMMAND SOUTHEAST
NAVAL AIR STATION JACKSONVILLE
IPT SOUTH ATLANTIC
MISSISSIPPI
JOHN C. STENNIS SPACE CENTER
SOF RIVERINE AND COMBATANT
CRAFT OPERATIONS FACILITY - PRE-FINAL
BOAT STORAGE BLDG. 2442 CATWALK FRAMING PLAN

CODE ID: N64412 SIZE: 0
SCALE: AS SHOWN
DRAWING NO.: P-210
STA. PROJ. NO.: S10247
WORK ORDER NO.: N62467-05-0-0096
CONSTR. CONTR. NO.:
NAVFAC DRAWING NO.:
SHEET: 70 OF 117

DATE: 01 JAN 2009
S22

REVDATE: A B C D

1 2 3 4 5