


1 FOUNDATION PLAN  
SCALE: 3/8" = 1'-0"


FOUNDATION

**GENERAL NOTES**


1. ALL DIMENSIONS ARE EDGE OF CONCRETE (EOC) TO EDGE OF CONCRETE (EOC) UNLESS NOTED OTHERWISE.
2. CONCRETE MIX SHALL HAVE A MINIMUM COMPRESSIVE STRENGTH OF 4000 PSI AT 28 DAYS. CONCRETE MIX SHALL BE IN ACCORDANCE WITH ACI-318.
3. ALL CONVENTIONAL REINFORCING STEEL SHALL MEET ASTM-A615 (GRADE 60).
4. ONE LAYER OF POLYETHYLENE VAPOUR BARRIER SHALL BE PLACED UNDER ALL CONCRETE. VAPOR RETARDER TO BE MINIMUM 10 MIL THICKNESS, ASTM E 1745 CLASS A. PERMEANCE LESS THAN 0.1 PERMS, EQUAL TO STENO INDUSTRIES STENO KEAR ECOHIELD-E 15 MIL BY PRNO, OR EQUIVALENT BY FLATIRON FILMS. PROVIDE APPROPRIATE ACCESSORIES FOR A COMPLETE SYSTEM.
5. ALL REINFORCING STEEL AND MESH SHALL BE SECURELY SUPPORTED TO PREVENT BOTH VERTICAL AND HORIZONTAL MOVEMENT DURING CONCRETE PLACEMENT.
6. THE CONTRACTOR SHALL VERIFY ALL DIMOS, OFFSETS, BRICK LEDGES, RESPONSIBLE FOR SAME.
7. NON-SUBSTRATE CONCRETE FOOTINGS AND CORNERS. BEARING ON COMPACTED STRUCTURAL FILL AT LEAST 2 FEET BELOW FINISHED GRADE SHOULD BE DESIGNED FOR MINIMUM NET ALLOWABLE BEARING PRESSURES OF 1200 PSF AND 2000 PSF, RESPECTIVELY, BASED ON DEAD LOADS AND DESIGN LIVE LOADS.
8. ALL SOIL BELOW SLAB SHALL RECEIVE TERMITTE TREATMENT.

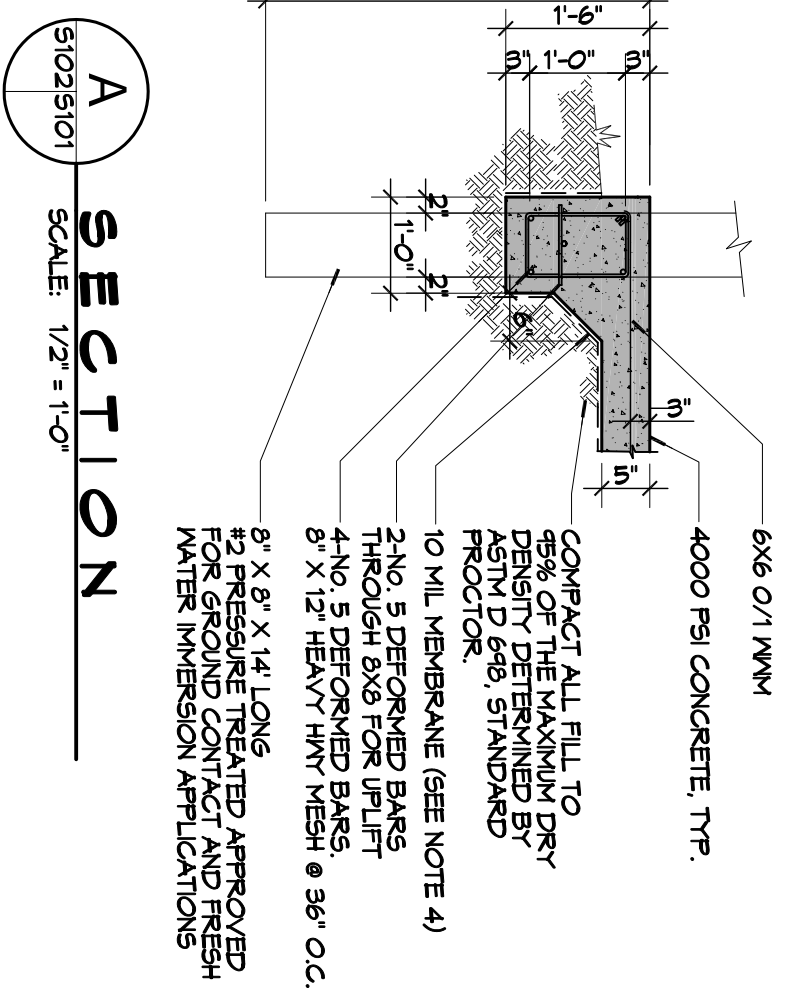

A SECTION  
SCALE: 1/2" = 1'-0"

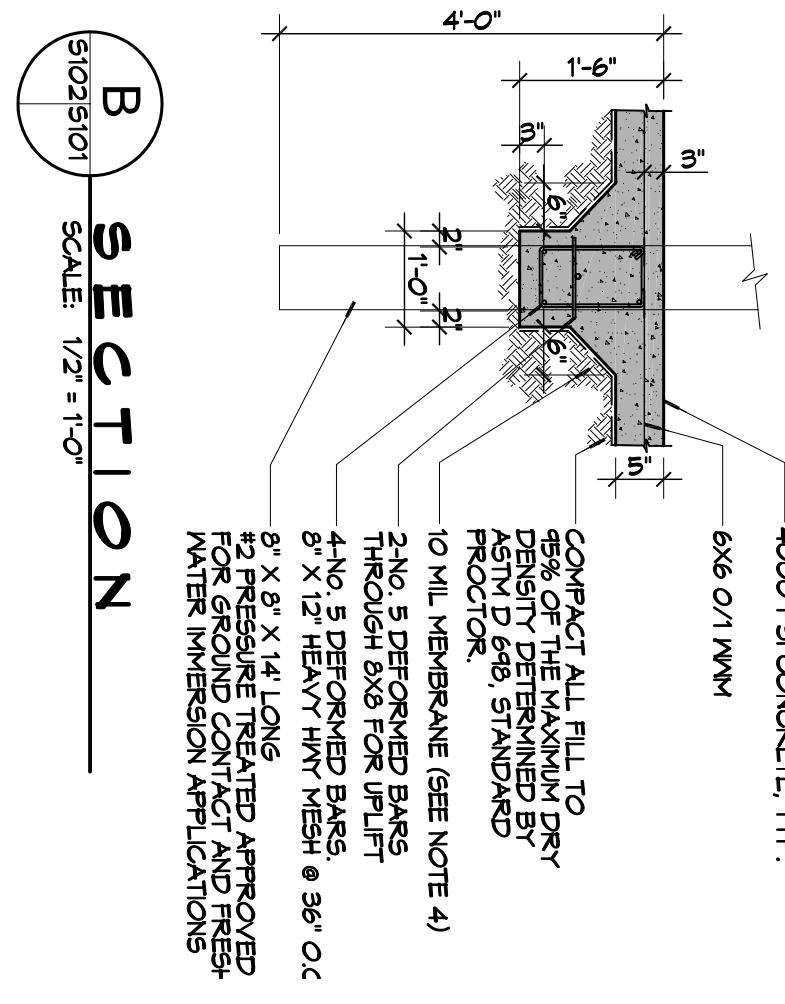

B SECTION  
SCALE: 1/2" = 1'-0"

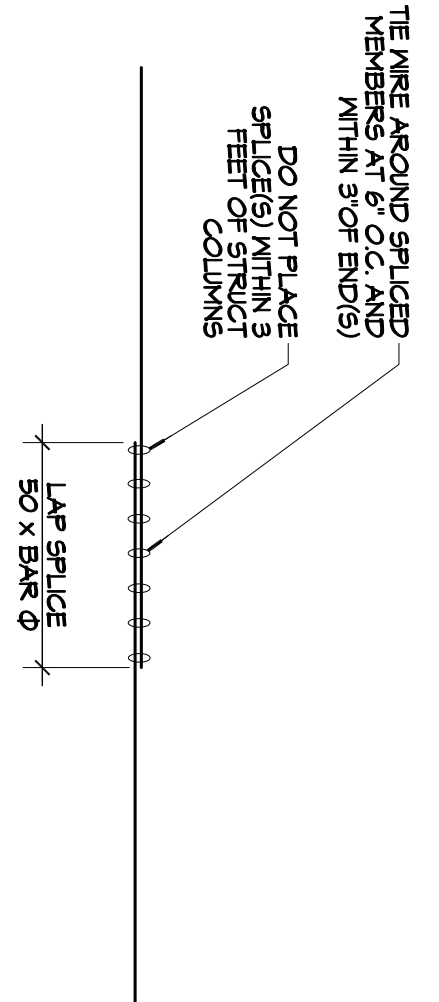

2 DETAIL  
SCALE: 1/2" = 1'-0"

REVISIONS		DATE
#	DESCRIPTION	

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**MAN CAMP BUS STOP**

SOUTHLAND FIELD  
LOUISIANA

JOB No: 2267 DATE: 11-23-15

DRAWN BY: CD CHECKED BY: BAM

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SHEET TITLE: FOUNDATION PLAN

DRAWING NUMBER: **5101**

SHEET No: 3 of 4