

PHILLIPS

Phone 770.394.1616 Fax 770.394.1314

CONSULTANT



PHILLIPS
NORTH TERRACES
400 PERIMETER CENTER TERRACE
SUITE 650
ATLANTA, GA 30346

SEAL

ISSUE & REVISION RECORD

#	DATE	DESCRIPTION
	07/07/14	BID SET

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PROJECT

SPRINGS AT
FREMAUX
TOWN CENTER
SLIDELL, LA

CLIENT

CONTINENTAL PROPERTIES
CONTINENTAL 294 FUND LLC
W134 N6075 EXECUTIVE PARKWAY
MEMPHIS, TN 38115
282.502.5500 * FAX 282.502.5522

PHILLIPS JOB NUMBER 1333104

ISSUE DATE 07/07/14

DRAWN BY/CHECKED BY PEM

DRAWING TITLE

UNIT 1GO -
MECHANICAL PLAN

SHEET NUMBER

M4.1GO

NORTH TERRACES
400 PERIMETER CENTER TERRACE
SUITE 650
ATLANTA, GEORGIA 30346

HVAC LEGEND AND SYMBOLS

- ⊖ THERMOSTAT
- ⊕ SWITCH
- ⊗ SUPPLY GRILLE
- RD INTAKE / RETURN SIDEWALL LOUVER - TWO LOUVERS CONNECTED WITH SHEET GALVANIZED SHEET METAL COLLAR.
- RD CEILING DIFFUSER WITH RADIATION DAMPER (SUPPLY DIFFUSERS)
- UCD R/A THRU 1" CLEAR CUT
- S-XX CFM DENOTES CEILING DIFFUSER SIZE AND CFM
- R-XX CFM DENOTES CEILING GRILLE SIZE AND CFM
- L-XX CFM DENOTES CEILING LOUVER SIZE AND CFM
- FLEXIBLE DUCTWORK
- TDx10 RIGID FIBERGLASS DUCTWORK
- 4" DRYER BOX WITH DUCTWORK - SEE DETAIL 7 ON SHEET M-6.02
- WALL MOUNTED BATHROOM FAN

CONDENSATE PIPING NOTES:


- DIRECT PRIMARY CONDENSATE LINES TO HUB DRAINS LOCATED IN MECHANICAL CLOSETS. REFER TO PLUMBING PLANS FOR LOCATION, ROUTING AND REQUIREMENTS. WHERE BUILDING HAS MULTIPLE STORIES, HUB DRAINS SHALL BE INSTALLED AT FIRST FLOOR ONLY. CONDENSATE PIPES FROM UNITS ABOVE SHALL BE RUN INDIVIDUALLY AND FULL SIZE TO DISCHARGE INDIRECTLY INTO THE HUB DRAIN ON THE LOWEST FLOOR. ALL HORIZONTAL SECTIONS OF DRAIN PIPING SHALL BE INSTALLED IN UNIFORM ALIGNMENT AT A UNIFORM SLOPE. MINIMUM 1%.
- AN AUXILIARY DRAIN PAN SHALL BE PROVIDED UNDER THE UNIT. SUCH PAN SHALL BE EQUIPPED WITH A WATER-LEVEL DETECTION DEVICE THAT WILL SHUT OFF THE UNIT UPON DETECTION OF WATER. PAN CONSTRUCTION SHALL BE PER CODE REQUIREMENTS.
- CONDENSATE DRAINS SHALL BE TRAPPED PER MANUFACTURERS RECOMMENDATIONS.

DRYER EXHAUST NOTES:

- ALL CLOTHES DRYER DUCTS PENETRATING OR LOCATED WITHIN ANY FIRE BLOCKING DRAFT STOPPING OR ANY WALL, FLOOR, CEILING OR OTHER ASSEMBLY REQUESTED BY THE BUILDING CODE TO BE FIRE-RESISTANT RATES SHALL BE CONSTRUCTED OF RIGID METAL DUCTWORK, GALVANIZED STEEL OR ALUMINUM, WITH A MINIMUM THICKNESS OF GAUGE 28 TO 24 RESPECTIVELY AS SPECIFIED IN THE SMACNA DUCT CONSTRUCTION STANDARDS AND CURRENT EDITION OF THE INTERNATIONAL MECHANICAL CODE.
- CONTRACTOR SHALL INSTALL RECESSED DRYER VENT BOX "IN-O-VENT TECHNOLOGIES" MODEL 425 TO ELIMINATE BENDS IN FLEX EXHAUST DUCT.
- UNLESS NOTED OTHERWISE THE DRYER VENT OUTLET SHALL BE LOCATED A MINIMUM 3'-0" FROM THE OPERABLE PORTION OF ALL WINDOWS AND OTHER AIR INTAKES.
- ON MULTI-STORY BUILDINGS, ROUTE DRYER VENT FROM TOP FLOOR TO AN APPROVED SOPHIT.
- EXHAUST DUCTWORK SHALL BE SUPPORTED AT 4'-0" INTERVALS.
- PROTECTIVE SHIELD PLATES SHALL BE PLACED PER LATEST EDITION OF INTERNATIONAL MECHANICAL CODE.
- PROVIDE A PERMANENT LABEL TO IDENTIFY THE EQUIVALENT LENGTH OF THE CONCEALED EXHAUST DUCT. THE LABEL SHALL BE PERMANENTLY ATTACHED IN A VISIBLE LOCATION WITHIN 6'-0" OF DRYER CONNECTION.
- DRYER VENT TOTAL EQUIVALENT LENGTH CAN BE SIGNIFICANTLY REDUCED USING LONG RADIUS ELBOWS. REFER TO TABLE 504.5.4.1 INTERNATIONAL MECHANICAL CODE FOR DUCT FITTING EQUIVALENT LENGTHS. CONTRACTOR SHALL PROVIDE FITTINGS AS INDICATED ON PLANS.

TOTAL EQUIVALENT DRYER EXHAUST LENGTH	
TOTAL LENGTH	35 FT.
NUMBER OF 90° ELBOWS	1
NUMBER OF 45° ELBOWS	1
TOTAL EQUIVALENT LENGTH	44 FT

BOOSTER FAN IS NOT REQUIRED BASED ON THIS MODEL. SEE DETAIL 7 ON SHEET M-6.02. IF DIFFERENT MODEL IS USED BOOSTER FAN MAY BE REQUIRED.

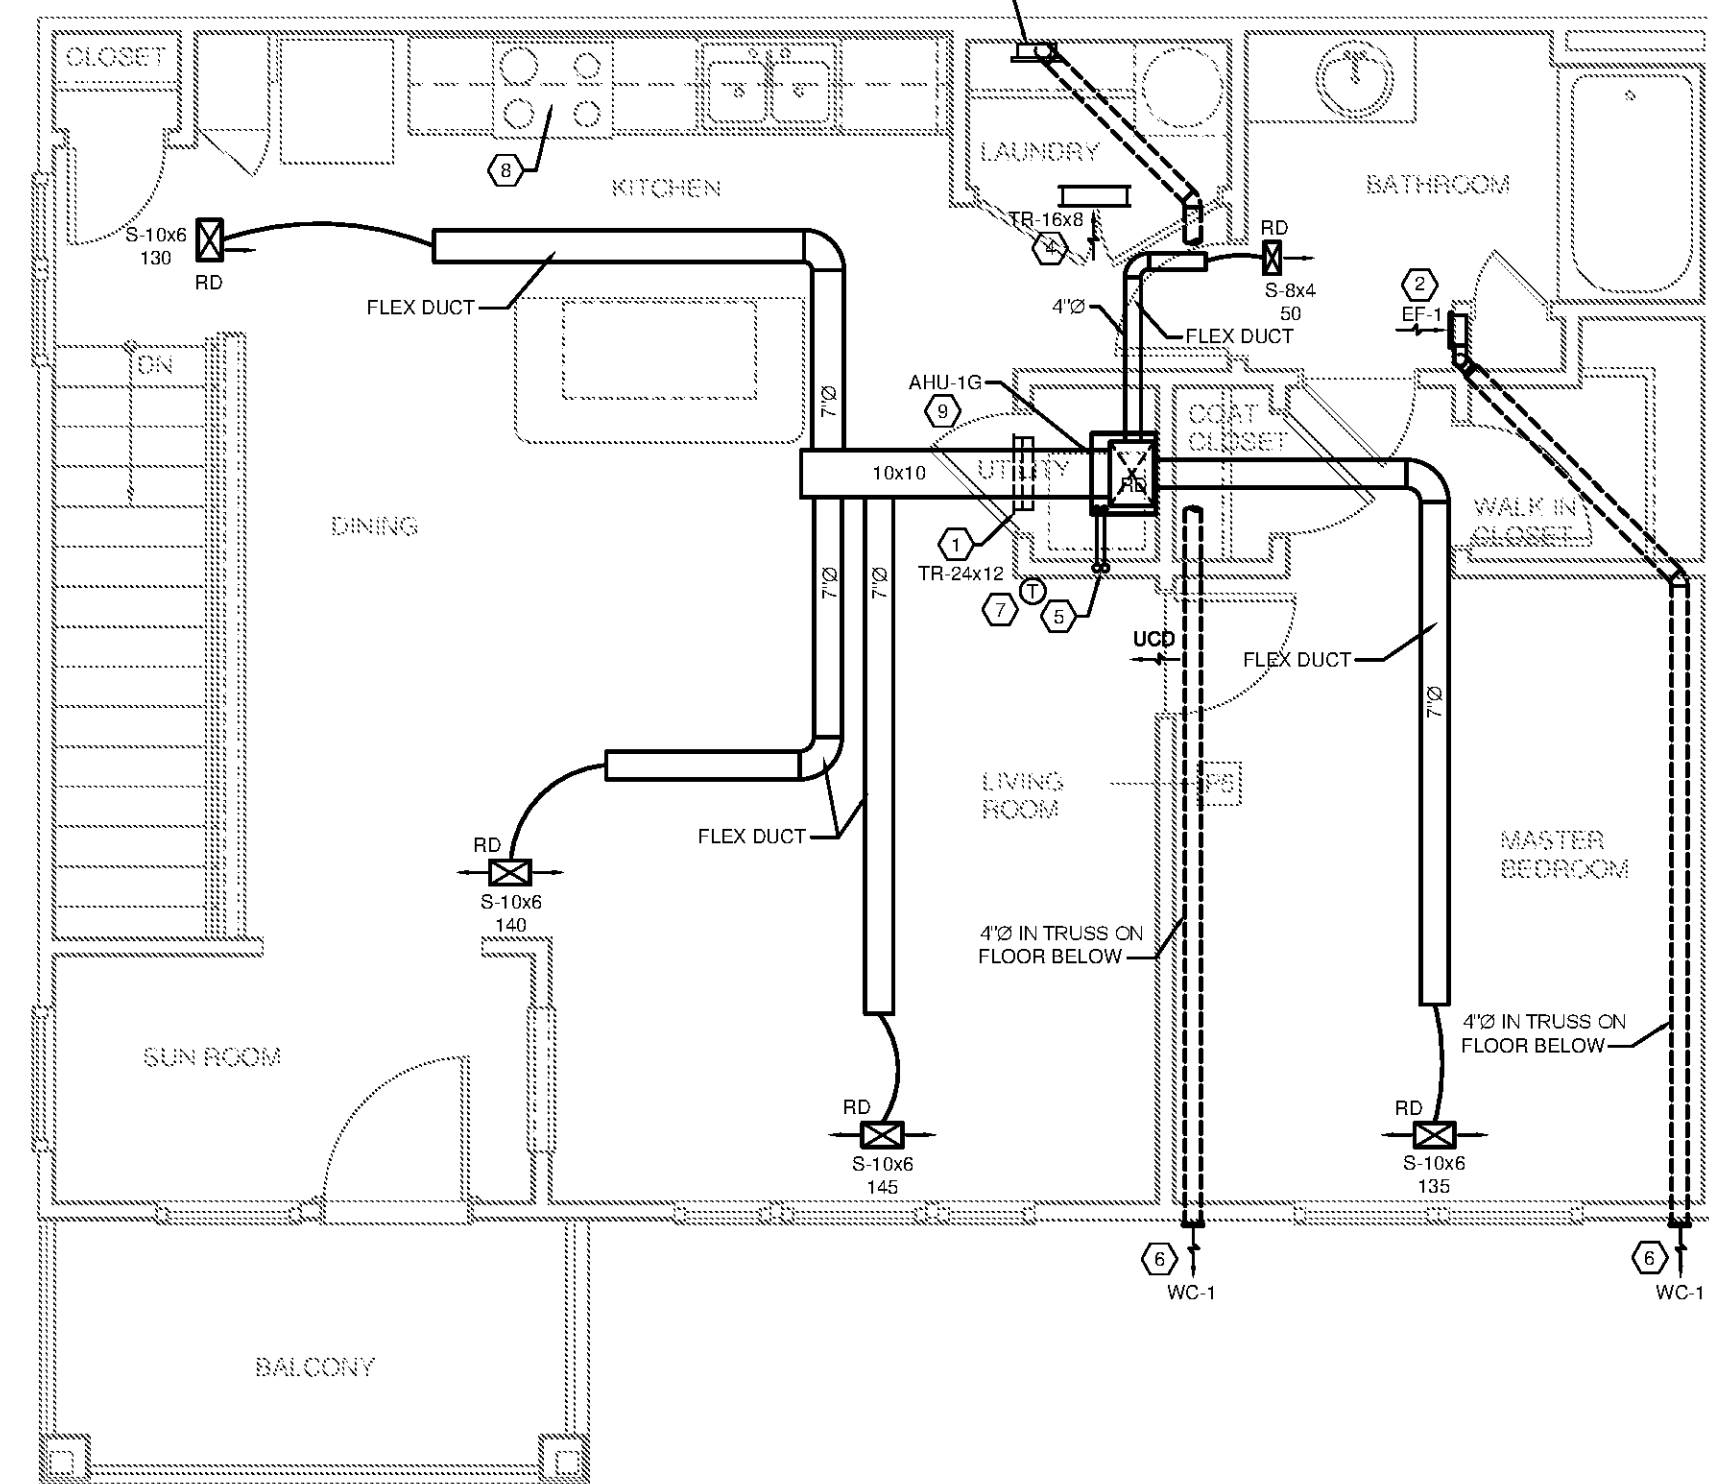

UNIT 1GO - MECHANICAL PLAN
1/4" = 1'-0"

AG PLAN CODE NOTES

- PROVIDE R/A THRU 24x12 WALL MOUNTED GRILLE ABOVE DOOR. GRILLE TO BE CONNECTED WITH GALVANIZED SHEET METAL COLLAR.
- EF-1 TO EXHAUST OUT THRU EXTERIOR WALL. SEE MANUFACTURER'S RECOMMENDATIONS FOR INSTALLATION.
- 4" DRYER EXHAUST DUCT CONNECTED TO DRYER VENT BOX - SEE DETAIL 7 ON SHEET M-6.02. VENT THRU WALL. SEE PLAN VIEW FOR DUCT ROUTING. ALL VENT MUST BE 3 FT. FROM ANY OPENABLE WINDOW OR DOOR.
- WALL MOUNTED INTAKE LOUVER FOR DRYER MAKE-UP AIR TO BE MOUNTED ABOVE DOORS IN DRYER CLOSET. LOUVER TO BE CONNECTED WITH GALVANIZED SHEET METAL COLLAR. SEE DRAWING FOR GRILLE SIZE.
- REFRIGERANT LINES UP THRU INTERIOR WALL FROM UNDERGROUND TO FEED AHU AT GROUND AND UPPER LEVELS. COORDINATE EXACT LOCATION WITH PLUMBING LINES.
- BATHROOM OR DRYER EXHAUST WALL CAP. COORDINATE COLOR AND LOCATION WITH ARCHITECT. VENT MUST BE 3 FT. FROM ANY OPENABLE WINDOW OR DOOR.
- THERMOSTAT MOUNTED AT 48" AFF. COORDINATE WIRING AND CONNECTION WITH MECHANICAL CONTRACTOR.
- UL RATED DUCTLESS RANGE HOOD.
- AHU IS TO BE LOCATED ON THE FLOOR. SEE DETAIL 3 ON SHEET M-6.02.

