

REROOFING OF OLD 6TH GRADE WING: SLIDELL JUNIOR HIGH SCHOOL

333 PENNSYLVANIA AVE
SLIDELL, LA 70458
ST. TAMMANY PARISH SCHOOL BOARD PROJECT # 1321



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#	DESCRIPTION	DATE



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SLIDELL JUNIOR
HIGH SCHOOL

333 PENNSYLVANIA AVENUE
SLIDELL, LA 70458

ST. TAMMANY SCHOOL BOARD
PROJECT # 1321

JOB No: 2101 | DATE: MARCH 9, 2014 | DRAWN BY: KJK | CHECKED BY: KJK


SHEET TITLE:
COVER SHEET

DRAWING NUMBER:
COVER

ABBREVIATIONS

SYMBOLS USED AS ABBREVIATIONS:			
∠	ANGLE	FA	FIRE ALARM
c	CENTERLINE	FAS	FASTEN
[CHANNEL	FB	FACE BRICK
d	FENNY	FBD	FIBERBOARD
⊥	PERPENDICULAR	FBO	FURNISHED BY OTHERS
t	PLATE OR PROPERTY LINE	FBD	FLOOR DRAIN
∅	DIAMETER	FE	FIRE EXTINGUISHER
	ABBREVIATIONS:	FE	FIRE EXTINGUISHER CAB
A	FRESH AIR	FF	FACTOR FINISH
ABV	ABOVE	FFL	FINISH FLOOR LINE
A/C	AIR CONDITIONER	FHC	FIRE HOSE CABINET
ACT	ACOUSTICAL CEILING TILE	FIN	FINISHED
ADD	ADDENDUM	FJT	FLUSH JOINT
ADH	ADHESIVE	FLG	FLASHING
ADJ	ADJUSTIBLE	FLR	FLOOR
AF	ABOVE FINISH FLOOR	FLUOR	FLUORESCENT
AGG	AGGREGATE	FLX	FLEXIBLE
ALT	ALTERNATE	FND	FOUNDATION
ALUM	ALUMINUM	FOC	FACE OF CONCRETE
ANC	ANCHOR	FOF	FACE OF FINISH
ANOD	ANODIZED	FOM	FACE OF MASONRY
ARCH	ARCHITECTURAL	FOS	FACE OF STUD(S)
ASPH	ASPHALT	FFL	FLOOR PLATE
AUTO	AUTOMATIC	FR	FRAMED/FRAMING
		FRG	FIRE-RESISTANT COATING
BC	BRICK COURSE	FRG	FORGED
BD	BOARD	FRT	FIRE-RETARDANT
BEL	BELOW	FTG	FOOTING
BG	BUMPER GUARD	FJR	FURRING
BUT	BEAD JOINT		
BIT	BUTIMINOUS	GA	GAUGE
BLDG	BUILDING	GALV	GALVANIZED
BLK	BLOCK	GC	GENERAL CONTRACTOR
BLKNG	BLOCKING	GD	GRADE
BM	BENCH MARK	GF	GROUND FACE
BO	BY OTHERS	GI	GALVANIZED IRON
BOT	BOTTOM	GKT	GASKET
BRG	BEARING	GL	GLASS/GLAZING
BRDG	BRIDGE/BRIDGING	GVL	GRAVEL
BS	BOTH SIDES	GWB	GYPSUM WALL BOARD
BM	BOTH WAYS		
CAB	CABINET	HBD	HARDBOARD
CCTV	CLOSED CIRCUIT TV	H/C	HANDICAPPED
CEM	CEMENT/CEMENTITIOUS	HC	HOLLOW CORE
CER	CERAMIC	HGJ	HORIZONTAL CONTROL JT
CFLG	COUNTERFLASHING	HDR	HEADER
CG	CORNER GUARD	HWR	HARDWARE
CHBD	CHALKBOARD	HJT	HEAD JOINT
CJT	CONTROL JOINT	HM	HOLLOW METAL
CK	CAULK	HOR	HORIZONTAL
CLNG	CEILING	HPT	HIGH POINT
CLR	CLEAR	HR	HANDRAIL
CLL	CONTRACT LIMIT LINE	HT	HEIGHT
CMU	CONCRETE MASONRY UNIT	HTG	HEATING
CNTR	COUNTER	HVAC	HEATING/VENTILATION/AIR CONDITIONING
COL	COLUMN		
COMB	COMBINATION	HWD	HARDWOOD
COMP	COMPOSITION		
CONC	CONCRETE	ID	INSIDE DIAMETER
CONST	CONSTRUCTION	INCL	INCLUDE(D)/(ING)
CONT	CONTINUOUS	INSF	INSULATING FILL
CORR	CORRUGATED	INSUL	INSULATE(D)/INSULATION
CPT	CARPET(ED)	INT	INTERIOR
CRC	COLD ROLLED CHANNEL	INTM	INTERMEDIATE
CRS	COURSE(S)	INV	INVERT
CS	COUNTERSINK	IPS	IRON PIPE SIZE
CS/WK	CASEWORK		
CT	CERAMIC TILE	J	JOIST
CTR	CENTER	JF	JOINT FILLER
CTRK	CURTAIN TRACK	JT	JOINT
CTSC	COUNTERSINK SCREW		
QUB C	QUIGGLE CURTAIN	KIT	KITCHEN
		KO	KNOCKOUT
D	DRAIN	KPL	KICKPLATE
DBL	DOUBLE		
DFL	DEFLECTION	L	LENGTH
DEMO	DEMOLITION/DEMOLISH	LAB	LABORATORY
DEP	DEPRESSED	LAD	LADDER
DIA	DIAMETER	LAM	LAMINATE(D)
DIAG	DIAGONAL	LAV	LAVATORY
DIM	DIMENSION	LB	LAS BOLT
DISP	DISPENSER	LBL	LABEL
DIV	DIVISION	LC	LIGHT CONTROL
DPR	DAMPER	LH	LEFT HAND
DS	DOWNSPOUT	LL	LIVE LOAD
DTA	DOVETAIL ANCHOR	LGMF	LIGHT GAUGE METAL FRAMING
DTL	DETAIL		
DW	DISHWASHER	LP	LIGHTPROOF
DWR	DRAWER	LPT	LOW POINT
DWG	DRAWING	LST	LIMESTONE
		LT	LIGHT
E	EAST	LTL	LINTEL
EA	EACH	LVR	LOUVER
EB	EXPANSION JOINT	LX	LIGHTWEIGHT
EJ	EXPANSION JOINT	LXC	LIGHTWEIGHT CONCRETE
EL	ELEVATION		
ELEC	ELECTRIC/ELECTRICAL	MAS	MASONRY
ELEV	ELEVATOR	MATL	MATERIAL(S)
EMER	EMERGENCY	MAX	MAXIMUM
ENC	ENCLOSURE	MBR	MEMBER
EO	ELECTRIC OUTLET	MDF	MEDIUM DENSITY FIBERBOARD
EP	ELECTRIC PANELBOARD		
EQ	EQUAL	MDO	MEDIUM DENSITY OVERLAY
EQFM	EQUIPMENT	MECH	MECHANICAL
ETR	EXISTING TO REMAIN	MED	MEDIUM
EVC	ELECTRIC WATER COOLER	MTL	METAL
EVH	ELECTRIC WATER HEATER	MFR	MANUFACTURE(R)
EXH	EXHAUST	MH	MANHOLE
EXMP	EXPANDED METAL PLATE	M/W	MICROWAVE
EXP	EXPOSED	MIN	MINIMUM
EXIST	EXISTING	MIR	MIRROR
EXT	EXTERIOR	MISC	MISCELLANEOUS
		MBR	MEMBRANE
		MO	MASONRY OPENING
		MOV	MOVEABLE
		MT	MOUNT(ED)/(ING)
		MULL	MULLION
		MNK	MILLWORK

GENERAL NOTES

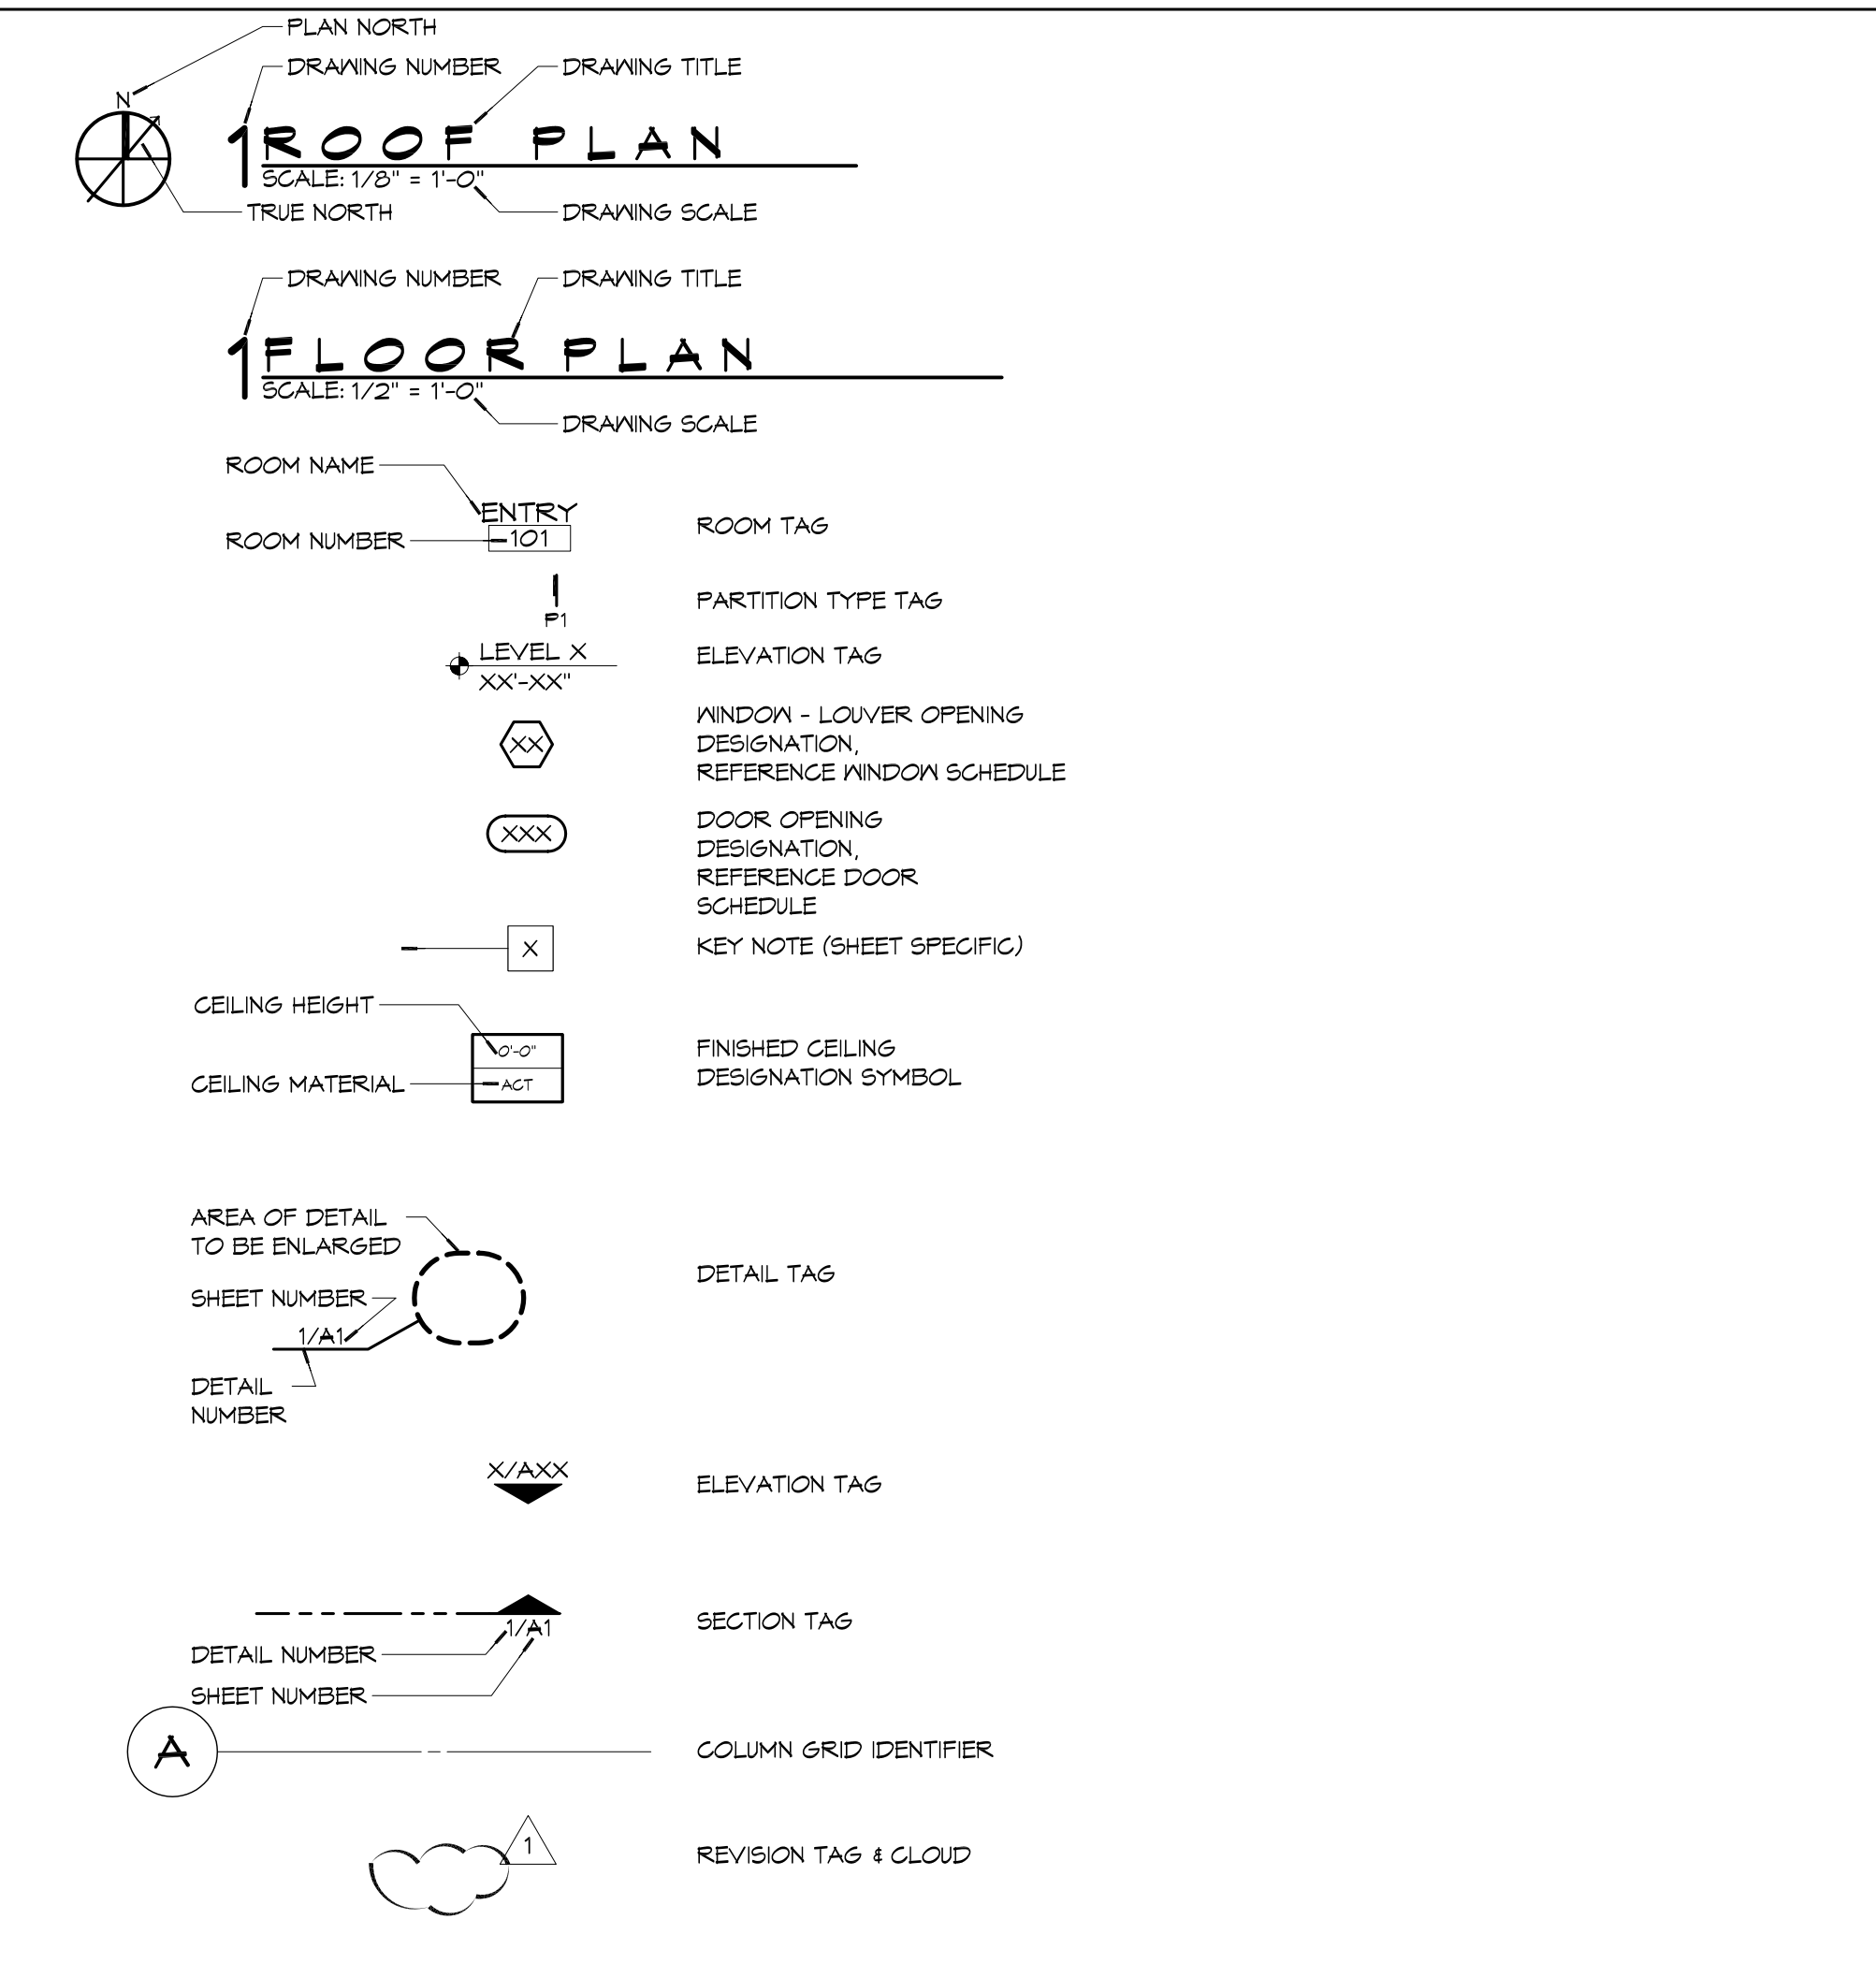

PROJECT STATISTICS

SQUARE FOOTAGE	
ROOF REPLACEMENT (SF)	21,000±
ROOF REPAIR/COATINGS (SF)	800±
TOTAL ROOF REPAIRS/REPLACEMENT (SF)	21,800±
PROJECT LOCATION:	
SLIDELL JUNIOR HIGH SCHOOL	
333 PENNSYLVANIA AVENUE	
SLIDELL, LA 70458	
OWNER:	
ST. TAMMANY PARISH SCHOOL BOARD	
321 N. THEARD	
COVINGTON, LA 70433	


SHEET INDEX

SHEET #	SHEET TITLE
COVER	COVER SHEET
G1	GENERAL INFORMATION SHEET
D1	ROOF DEMOLITION PLAN
A1	ROOF PLAN
A2	ROOF DETAILS


GENERAL NOTES

- ALL MATERIALS AND WORK, INCIDENTAL TO THE CONSTRUCTION OF THIS PROJECT, SHALL CONFORM TO ALL GOVERNING CODES, AND REGULATIONS OF AGENCIES IN AUTHORITY.
- CONTRACTOR SHALL PROVIDE ALL PUBLIC PROTECTIONS NECESSARY AS REQUIRED BY LAW.
- THE DRAWINGS, SPECIFICATIONS AND ANY SUBSEQUENTLY ISSUED ADDENDA, AMENDMENTS OR SUCH CHANGE ORDERS APPROVED BY THE OWNER AND THE CONTRACTOR ARE PART OF THESE CONTRACT DOCUMENTS.
- DO NOT SCALE DRAWINGS. CONSULT WITH THE ARCHITECT REGARDING ANY ITEMS IN THE CONTRACT DOCUMENTS THAT REQUIRE CLARIFICATION.
- VERIFY LOCATION OF ALL EQUIPMENT WITH THE ARCHITECT, PRIOR TO INSTALLATION.
- THE GENERAL CONTRACTOR SHALL VERIFY EXISTING CONDITIONS PRIOR TO COMMENCING WORK AND REPORT ANY AND ALL DISCREPANCIES TO THE ARCHITECT.
- CONTRACTOR VEHICLES AND EQUIPMENT NECESSARY FOR CONSTRUCTION MAY BE PARKED ON THE SITE. OTHER VEHICLES PARKED ON THE SITE REQUIRE THE OWNER'S PERMISSION.
- WORK INDICATED AS NOT IN CONTRACT, 'N/C' OR 'BY OTHERS', SHALL BE PERFORMED BY OWNER'S SEPARATE CONTRACTORS. THE GENERAL CONTRACTOR SHALL COOPERATE TO THE FULLEST EXTENT WITH ALL OTHER CONTRACTORS AND ASSIST IN COORDINATING THE WORK BY SEPARATE CONTRACTORS WITH THE WORK OF THIS CONTRACT.
- NAMING A CERTAIN BRAND, MAKE OR MANUFACTURER IS TO DESIGNATE THE GENERAL STYLE, TYPE, CHARACTER AND QUALITY STANDARD OF THE PRODUCT DESIRED. SUBSTITUTION REQUESTS MUST BE SUBMITTED PRIOR TO BIDDING.
- ALL MATERIALS/EQUIPMENT SHALL BE INSTALLED PER MANUFACTURER'S RECOMMENDATIONS. WORK NOT CONSISTENT WITH MANUFACTURER'S RECOMMENDATIONS WILL BE REJECTED BY OWNER/ARCHITECT.


MATERIAL DESIGNATIONS

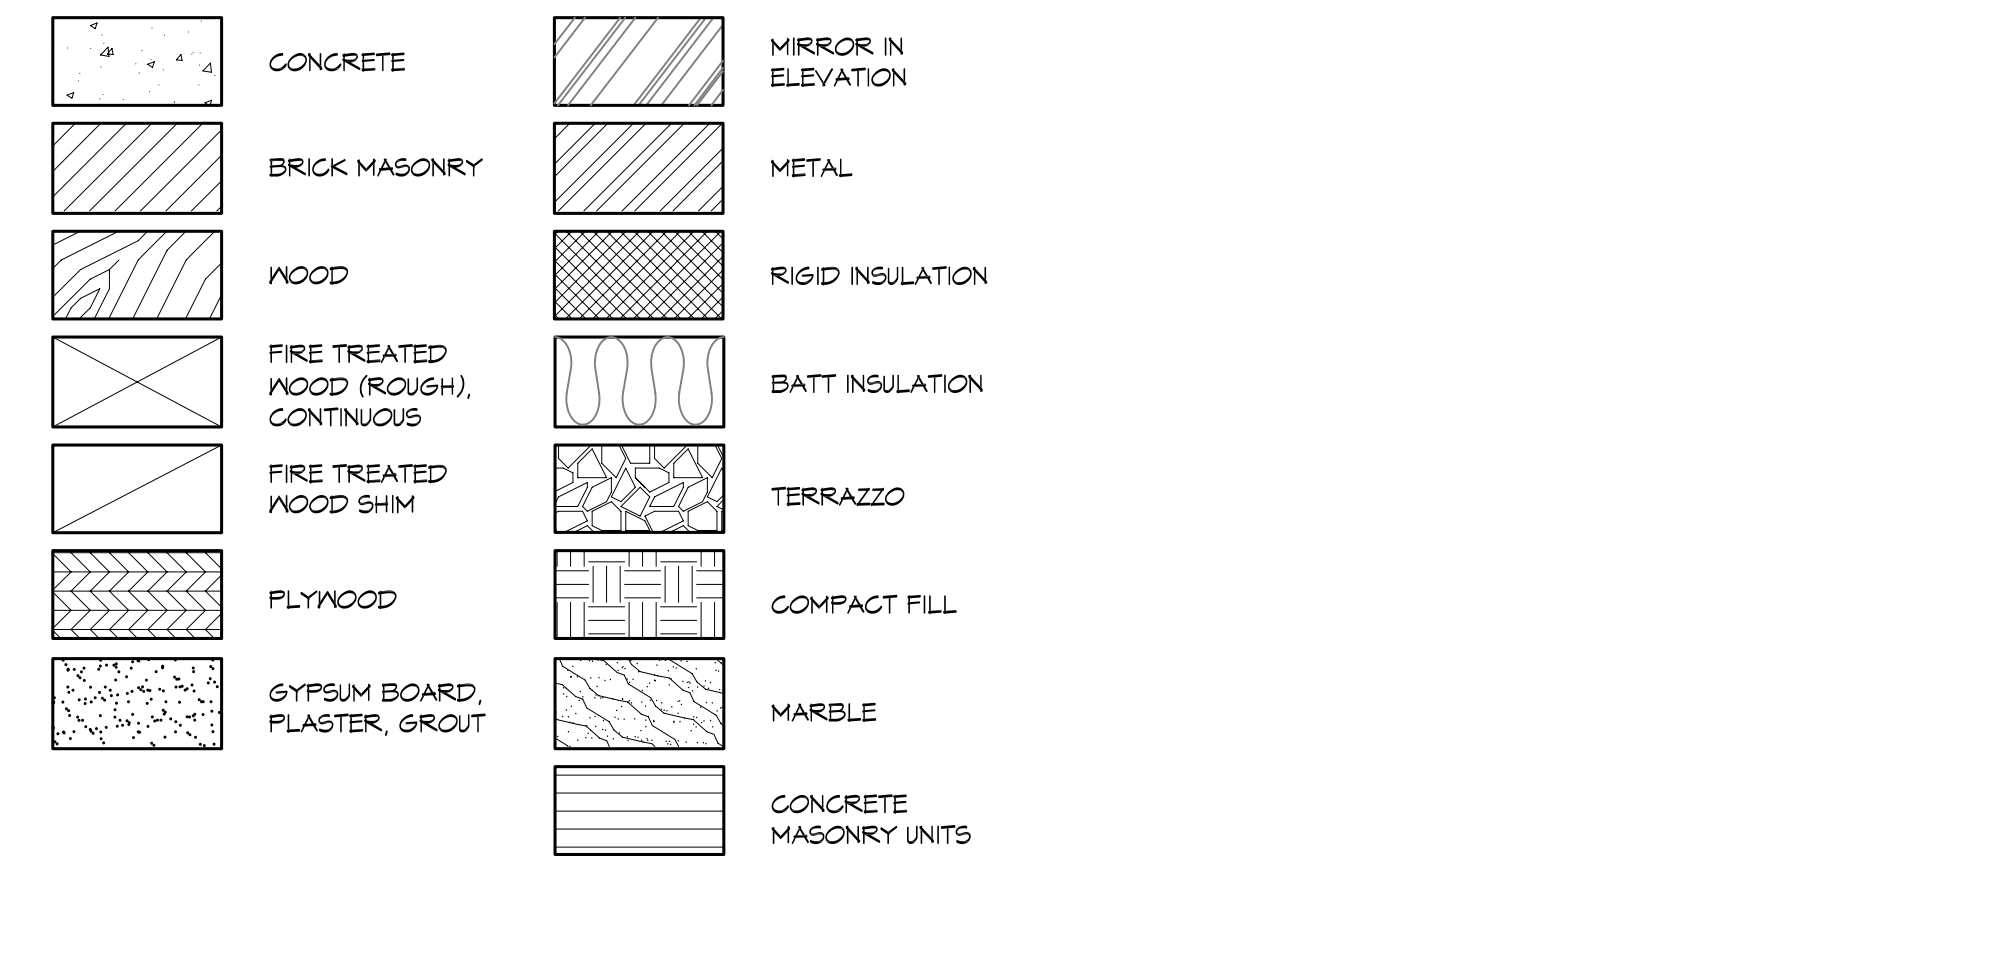

VICINITY MAP

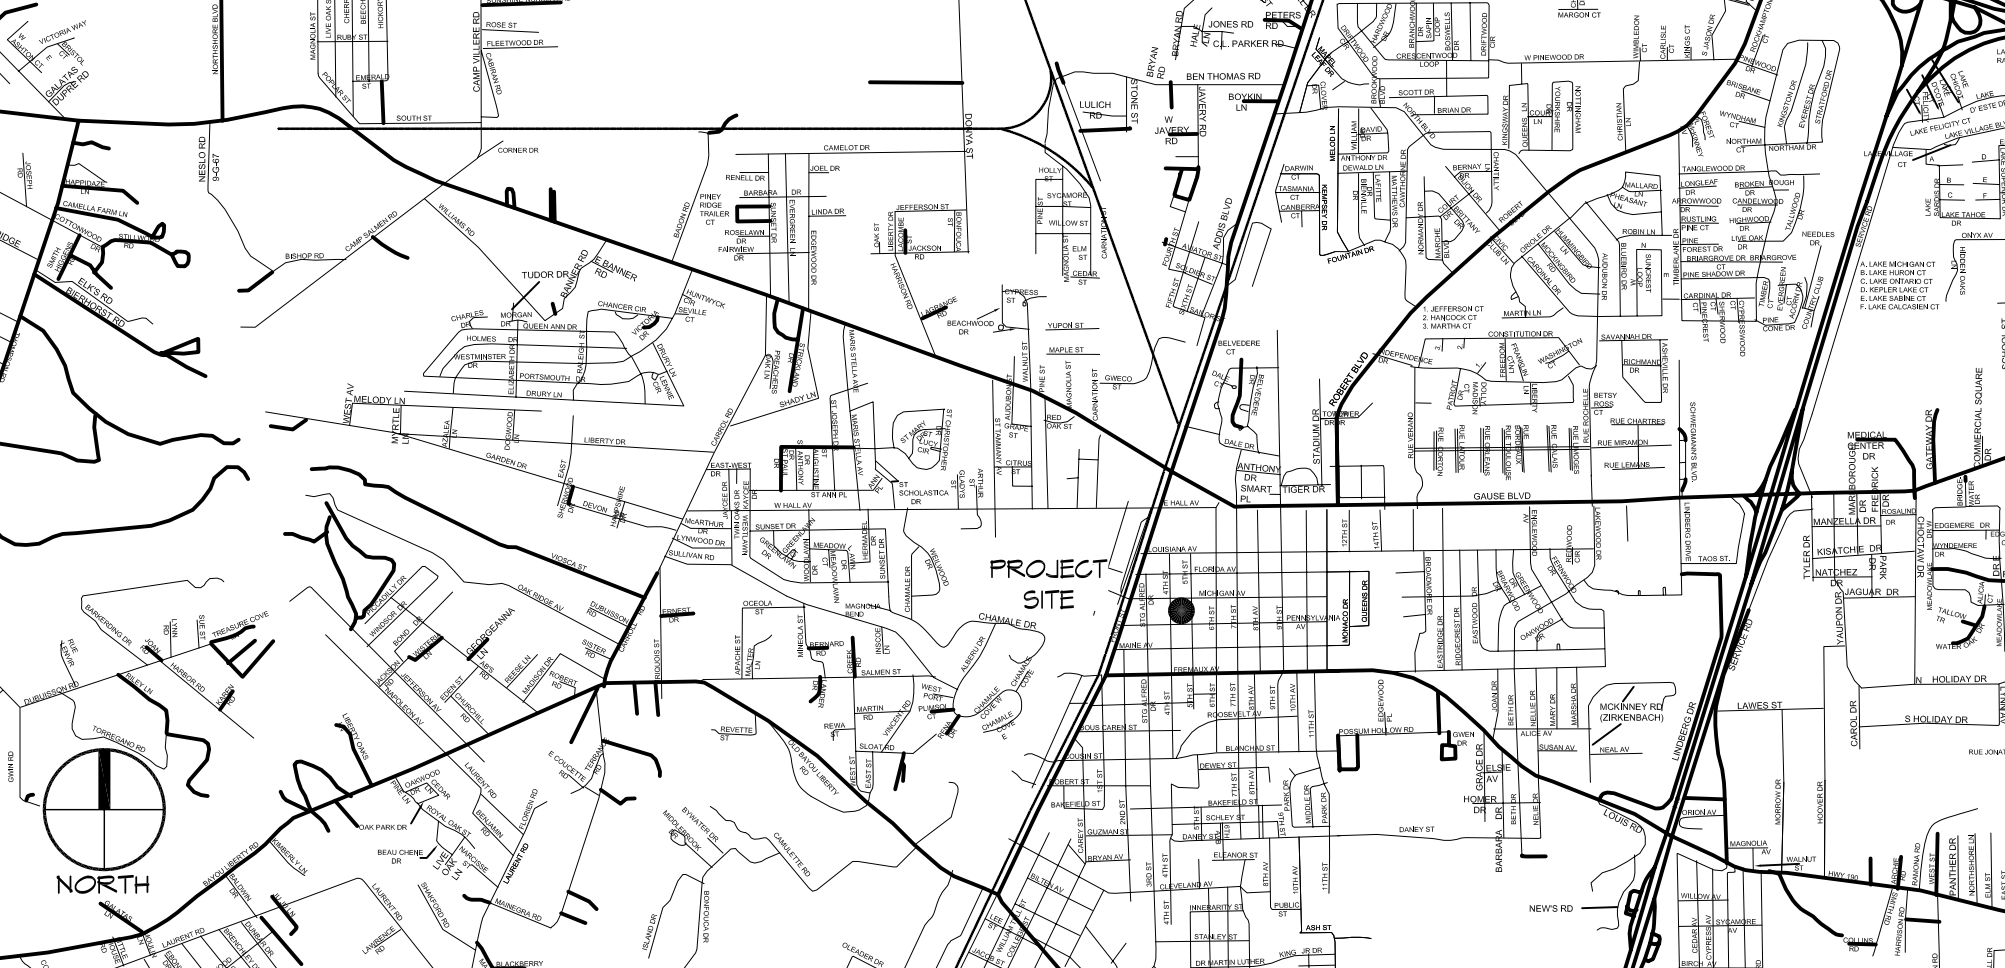

SITE PLAN

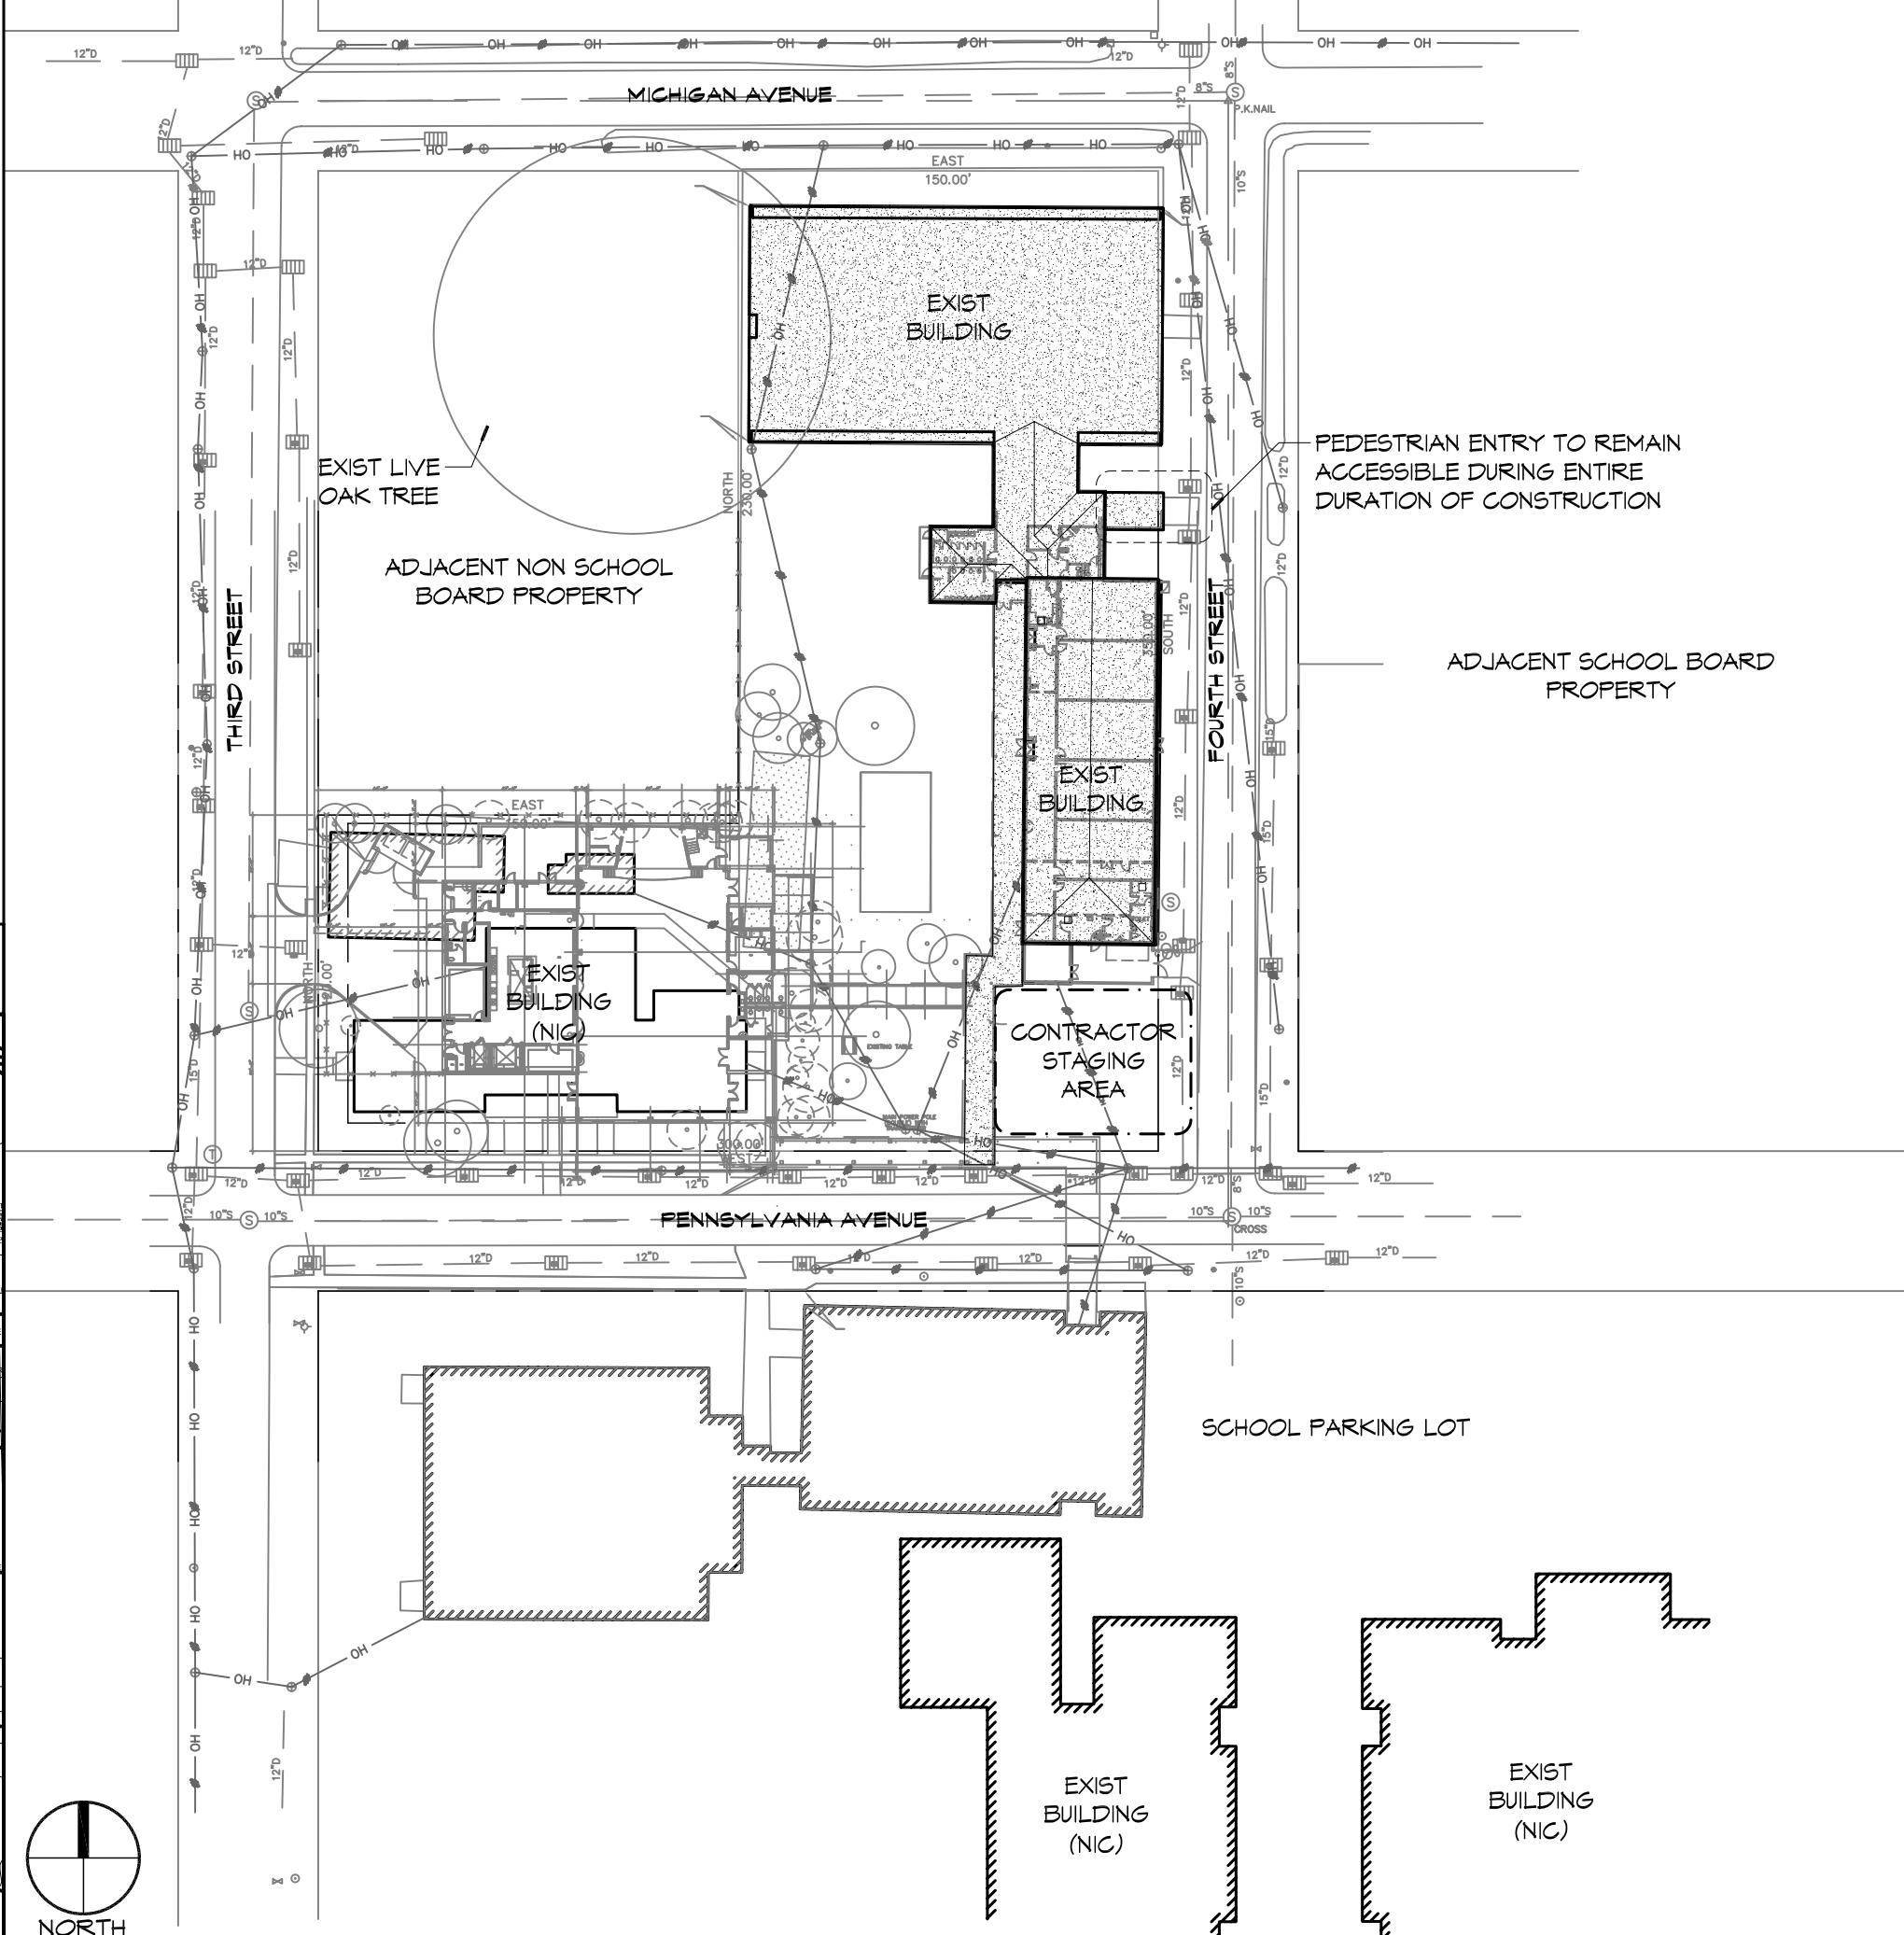


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#	DESCRIPTION	DATE

SEAL:

SLIDELL JUNIOR HIGH SCHOOL
REEROOFING OF OLD 6TH GRADE WING:
ST. TAMMANY SCHOOL BOARD
PROJECT # 1521
933 PENNSYLVANIA AVENUE
SLIDELL, LA 70458
JOB NO: 2181 DATE: MARCH 3, 2014
DRAWN BY: KJK CHECKED BY: KJK

SHEET TITLE:
GENERAL INFORMATION SHEET
DRAWING NUMBER:
G1
SHEET No: 2 of 5

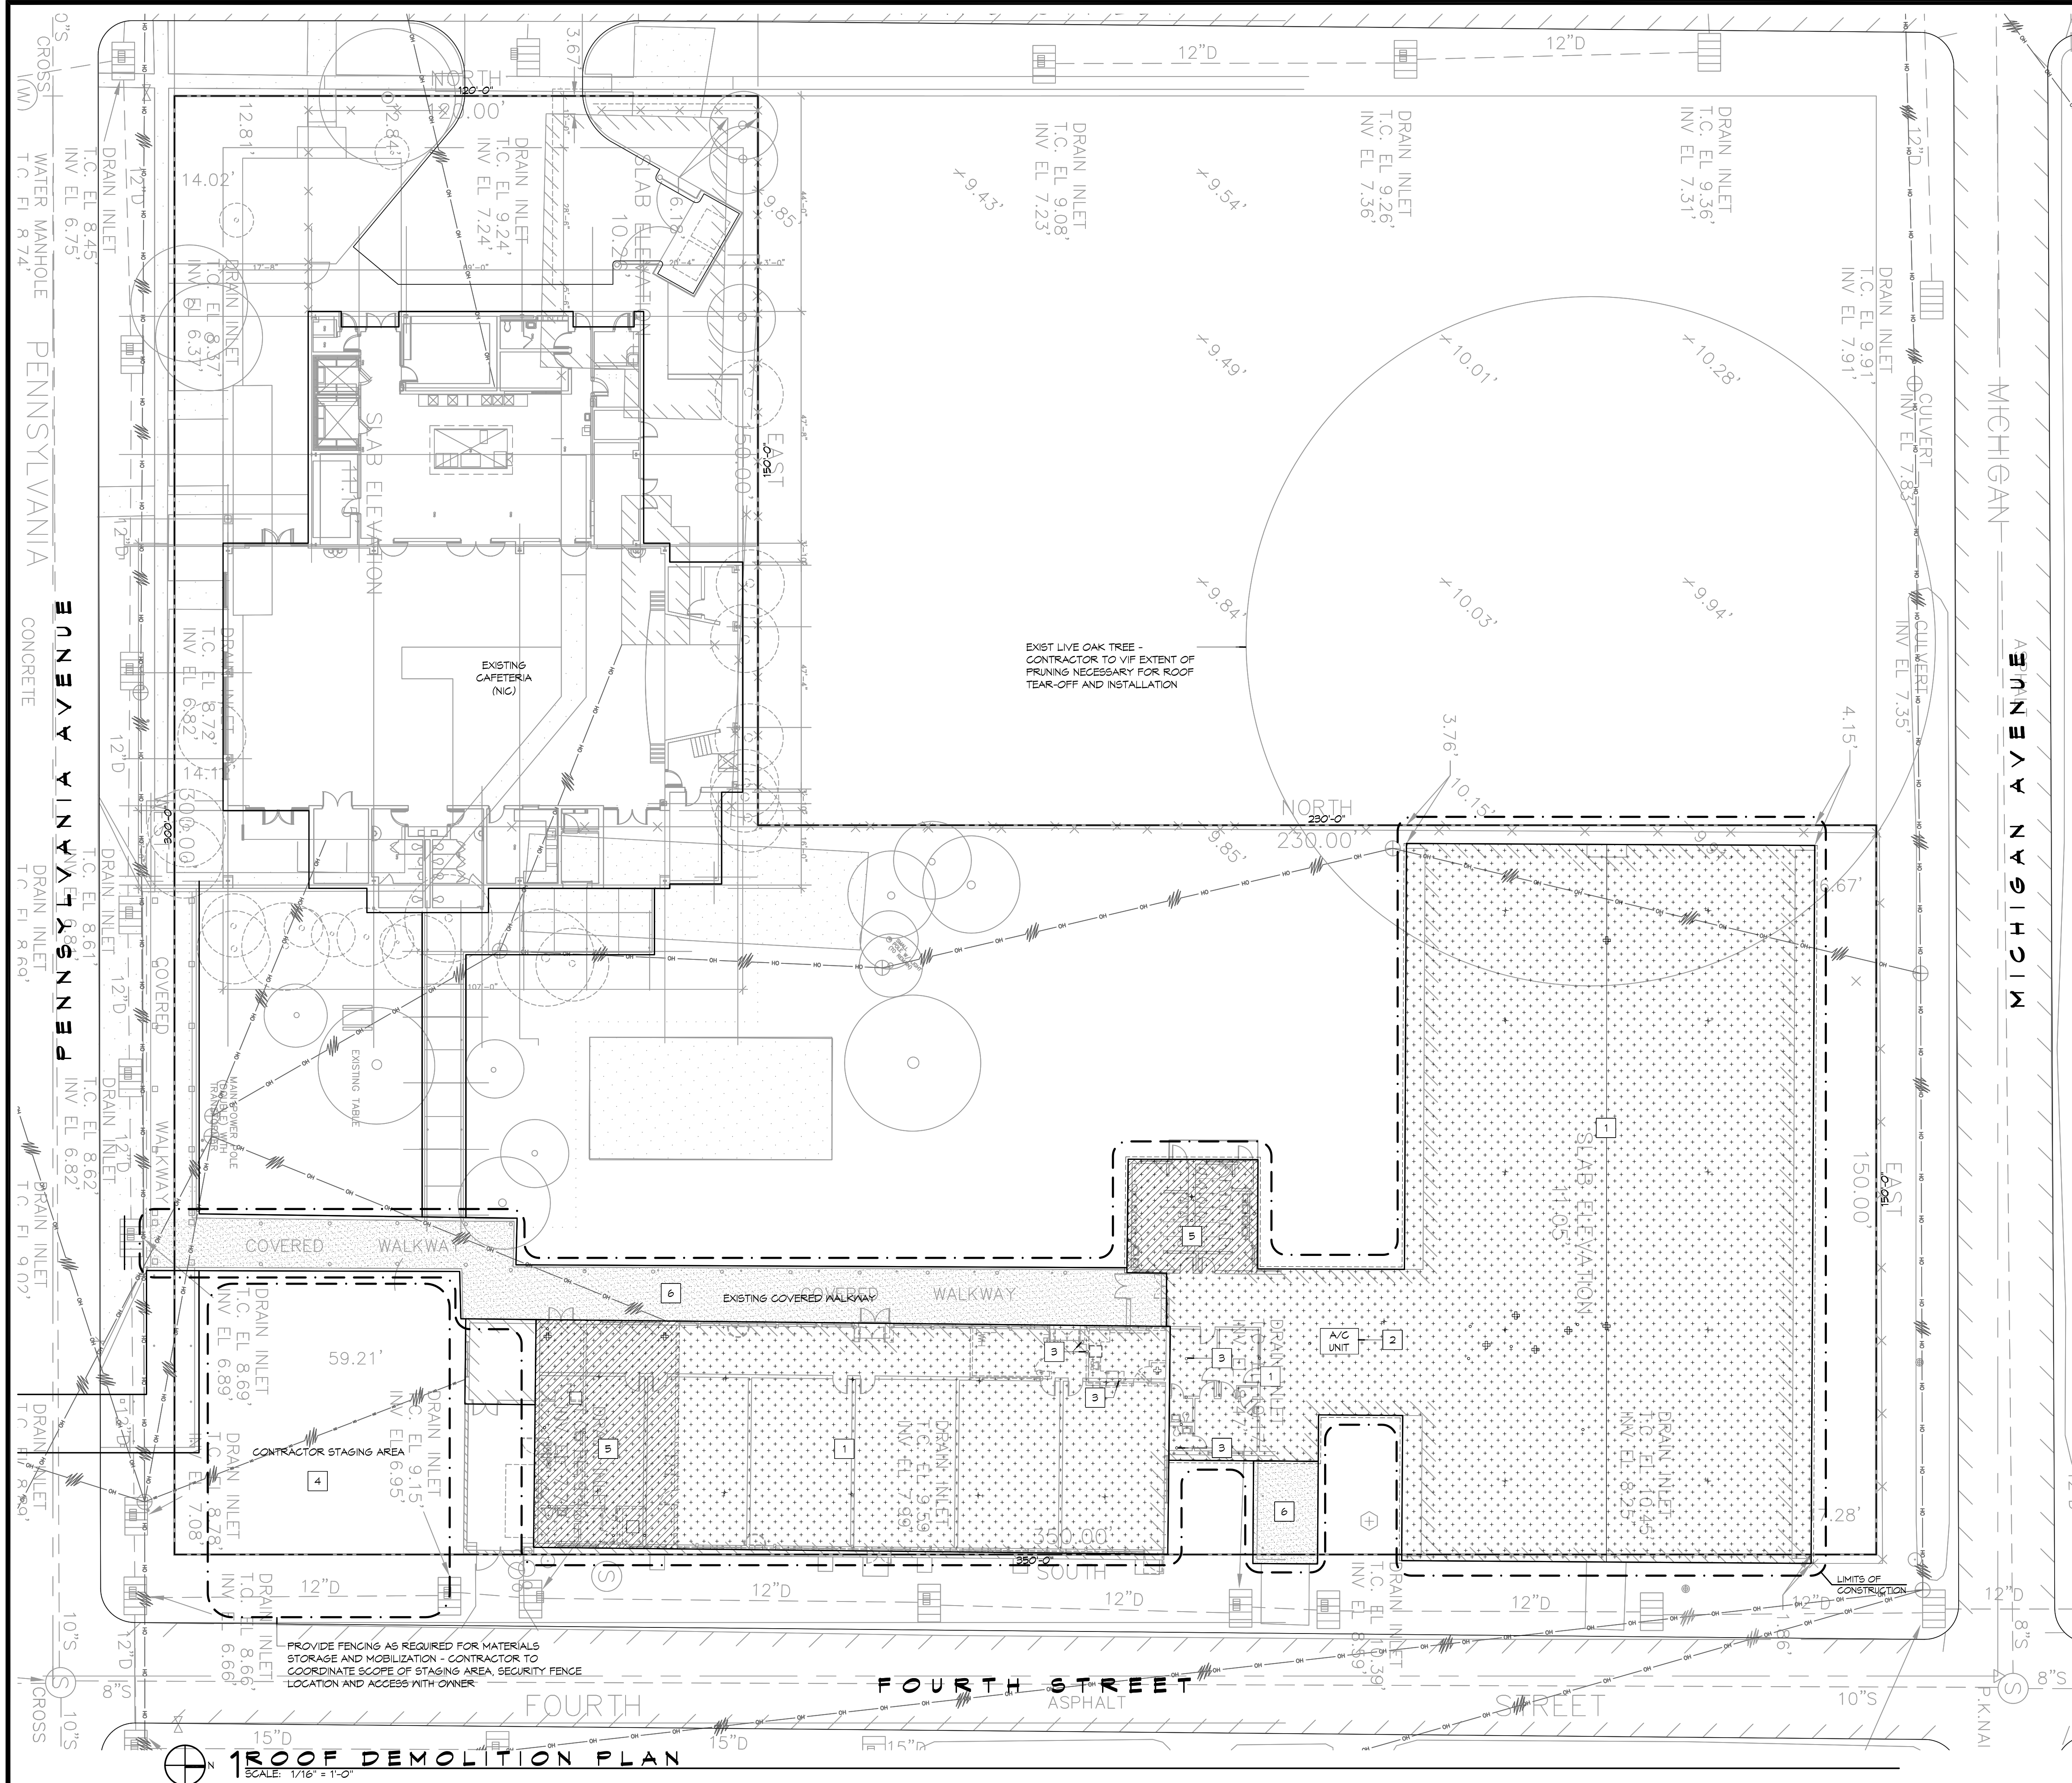

DEMOLITION NOTES

- REMOVE AS REQUIRED TO ACCOMPLISH WORK INDICATED IN THESE DOCUMENTS. ALL REQUIRED DEMOLITION WORK SHALL BE INCLUDED IN THE BASE BID PACKAGES SUBMITTED BY THE BIDDER.
- DO NOT ALLOW MATERIALS AND DEBRIS GENERATED BY DEMOLITION TO ACCUMULATE ON THE JOB SITE. REMOVE DAILY AND DISPOSE OF IN A LEGAL MANNER. NO ON-SITE SALE OR BURNING OF REMOVED ITEMS IS PERMITTED.
- THIS PLAN IS TO BE USED IN CONJUNCTION WITH THE ENTIRE SET OF CONSTRUCTION DRAWINGS. DO NOT REMOVE ANY ITEMS WITHOUT VERIFYING AND COORDINATING WITH ALL GENERAL TRADES AS TO HOW THEY RELATE TO THE OVERALL PROJECT.
- THE CONTRACTOR MUST TAKE ALL NECESSARY PRECAUTIONS TO ENSURE THE SAFETY OF THE PUBLIC AND/OR WORKMEN ON THE SITE TO PREVENT ACCIDENTS OR INJURY TO ANY PERSON ON OR ADJACENT TO THE PREMISES. THE CONTRACTOR SHALL COMPLY WITH ALL LAWS, ORDINANCES, AND REGULATIONS PERTAINING TO SAFETY AND THE PREVENTION OF ACCIDENTS.
- DATA ON THESE DRAWINGS ARE AS ACCURATE AS PLANNING CAN DETERMINE. BUT ABSOLUTE ACCURACY IS NOT GUARANTEED. FIELD VERIFICATION OF THE PLANS IS THE RESPONSIBILITY OF THE CONTRACTOR SINCE FINAL DISTANCES, LOCATIONS, AND HEIGHTS WILL BE DETERMINED BY ACTUAL FIELD CONDITIONS. CONTRACTOR TO FIELD VERIFY EXISTING CONDITIONS IN AREAS TO BE RENOVATED PRIOR TO BID IN ORDER TO PROVIDE AN ACCURATE BID AND BE AWARE OF ALL CONSTRUCTION METHODS NEEDED TO PROVIDE THE FINISHED PRODUCT AS SHOWN ON THE PLANS. DISCREPANCIES SHALL BE BROUGHT TO THE ATTENTION OF THE OWNER AND THE ARCHITECT FOR A DECISION TO RESOLVE CONFLICTS PRIOR TO BID.
- CONSTRUCTION IN AREAS TO BE RENOVATED SHALL BE CAREFULLY COORDINATED WITH THE OWNER PRIOR TO CONSTRUCTION. EXISTING EQUIPMENT WILL BE RELOCATED OR STORED AS PER OWNER'S DIRECTION. DISPOSE OF EXISTING EQUIPMENT ONLY AT THE DIRECTION OF THE OWNER. EQUIPMENT AND MATERIALS TO BE STORED SHALL BE PROTECTED FROM DAMAGE IN LOCATIONS ACCEPTABLE TO THE OWNER.
- DASHED LINES ON DEMOLITION DRAWINGS INDICATE EXISTING MATERIALS TO BE REMOVED. EQUIPMENT TO BE REUSED SHALL BE STORED AND PROTECTED FROM DAMAGE. ANY DAMAGE RESULTING FROM CONSTRUCTION WILL BE REPAIRED TO ITS ORIGINAL STATE.
- DASHED LINES ON DEMOLITION DRAWINGS INDICATE EXISTING MATERIALS TO BE REMOVED. EQUIPMENT TO BE REUSED SHALL BE STORED AND PROTECTED FROM DAMAGE. ANY DAMAGE RESULTING FROM CONSTRUCTION WILL BE REPAIRED TO ITS ORIGINAL STATE.
- DASHED LINES ON DEMOLITION DRAWINGS INDICATE EXISTING MATERIALS TO BE REMOVED. EQUIPMENT TO BE REUSED SHALL BE STORED AND PROTECTED FROM DAMAGE. ANY DAMAGE RESULTING FROM CONSTRUCTION WILL BE REPAIRED TO ITS ORIGINAL STATE.
- COORDINATE DEMOLITION AND ROOFING OPERATIONS WITH OWNER WHERE THE AFFECT EXISTING WORK AREAS AND NORMAL OPERATING PROCEDURES.
- EXISTING TREES AND OTHER VEGETATION ON SITE ARE TO REMAIN. PROTECT TRUNKS, BRANCHES, AND ROOT SYSTEM FROM DAMAGE DURING CONSTRUCTION.
- CONTRACTOR TO INSPECT AREAS ADJACENT TO DEMOLISHED ELEMENTS FOR THE PRESENCE OF TERMITE INFESTATION AND REPORT FINDINGS TO OWNER. COORDINATE NEEDED REPAIRS WITH OWNER PRIOR TO COMMENCEMENT OF NEW WORK IN AFFECTED AREA.
- ALL ROOF PENETRATION/ACCESSORIES LOCATIONS SHOWN ARE APPROXIMATELY ONLY. FIELD VERIFY WHERE EXACT LOCATIONS ARE REQUIRED.
- ALL EXIST WOOD BLOCKING ASSOCIATED WITH ROOF MEMBRANE IN THIS SCOPE OF WORK SHALL BE REMOVED. CONTRACTOR TO FIELD VERIFY AND REPORT TO ARCHITECT ANY BLOCKING THAT IS IN SATISFACTORY CONDITION SO THAT IT CAN REMAIN AS PART OF NEW ROOFING SYSTEM. THE VALUE OF ANY REMAINING WOOD BLOCKING SHALL BE CREDITED BACK TO OWNER IN ACCORDANCE WITH UNIT VALUE REQUIREMENTS.

DEMOLITION KEYNOTES

MK	DESCRIPTION
1	REMOVE EXIST MODIFIED BITUMEN MEMBRANE SYSTEMS TO EXIST STR DECK, INCLUDING ASSOCIATED MTL EDGE FLASHING, GUTTERS, DECK VENTS, AND ALUM FLASHING EXCEPT WHERE INDICATED AS 'EXIST TO REMAIN'. TOP SURFACE OF STR CONC DECK TO REMAIN INTACT. DO NOT REMOVE EXIST DECK UNLESS DIRECTED BY ARCHITECT OR OWNER.
2	EXIST ROOFTOP A/C UNIT TO REMAIN. REMOVE EXIST MD CURBS AND REPLACE WITH NEW TRTD WOOD CURBS. UNIT TO REMAIN FUNCTIONING AND IN WORKING ORDER DURING ENTIRE CONSTRUCTION PROCESS UNLESS SHUTDOWN IS PERMITTED BY AND COORDINATED WITH OWNER.
3	REMOVE EXIST PLUMBING VENT/VENT STACK TO FLUSH WITH TOP OF DECK. REMAINING VENT TO BE ABANDONED IN PLACE.
4	REMOVE EXIST CONC BENCHES, BIRD BATH, AND PLAQUE AND COORDINATE WITH OWNER FOR STORAGE. REPLACE AND REINSTALL ITEMS UPON COMPLETION OF WORK. COORDINATE WITH OWNER FOR NEW LOCATION OF ITEMS. PLAQUE SHALL BE RESET IN GROUND WITH NEW CONC FOOTING.
5	REMOVE EXIST MODIFIED BITUMEN MEMBRANE SYSTEMS TO EXIST STRUC DECK, INCLUDING ASSOCIATED MTL EDGE FLASHING, GUTTERS, DECK VENTS, AND ALUM FLASHING EXCEPT WHERE INDICATED AS 'EXIST TO REMAIN'. ALL EXIST ROOF DECK PENETRATIONS (GRAVITY VENTS, HOOD VENT, ETC.) TO REMAIN UNDISTURBED IN THIS AREA. TOP SURFACE OF STR CONC DECK TO REMAIN INTACT. DO NOT REMOVE EXIST DECK UNLESS DIRECTED BY ARCHITECT OR OWNER.
6	EXIST MODIFIED BITUMEN ROOF MEMBRANE TO REMAIN INTACT. PREPARE EXIST CAP SHEET TO RECEIVE NEW COATING IN COMPLIANCE WITH MFR RECOMMENDATIONS AND SPECIFICATIONS.

LEGEND

SYMBOL	DESCRIPTION
⊖	PLUMBING VENT/VENT STACK
⊕	METAL VENT HOUSING
+	DECK VENT
---	EXIST MTL GUTTER AND ATTACHED DOWNSPOUT TO BE REMOVED
— — —	EXIST OVERHEAD (OH) ELEC WIRES. CONTRACTOR TO FIELD VERIFY CLEARANCES WHERE NECESSARY TO CONDUCT WORK.
[Pattern]	EXISTING MODIFIED BITUMEN ROOF MEMBRANE TO REMAIN. SEE DEMOLITION KEYNOTE 6.
[Pattern]	EXISTING MODIFIED BITUMEN ROOF MEMBRANE SYSTEM TO BE REMOVED. SEE DEMOLITION KEYNOTE 1.
[Pattern]	EXISTING MODIFIED BITUMEN ROOF MEMBRANE SYSTEM TO BE REMOVED. ALL EXISTING ROOF DECK PENETRATIONS THIS AREA TO REMAIN INTACT. SEE DEMOLITION KEYNOTE 5.

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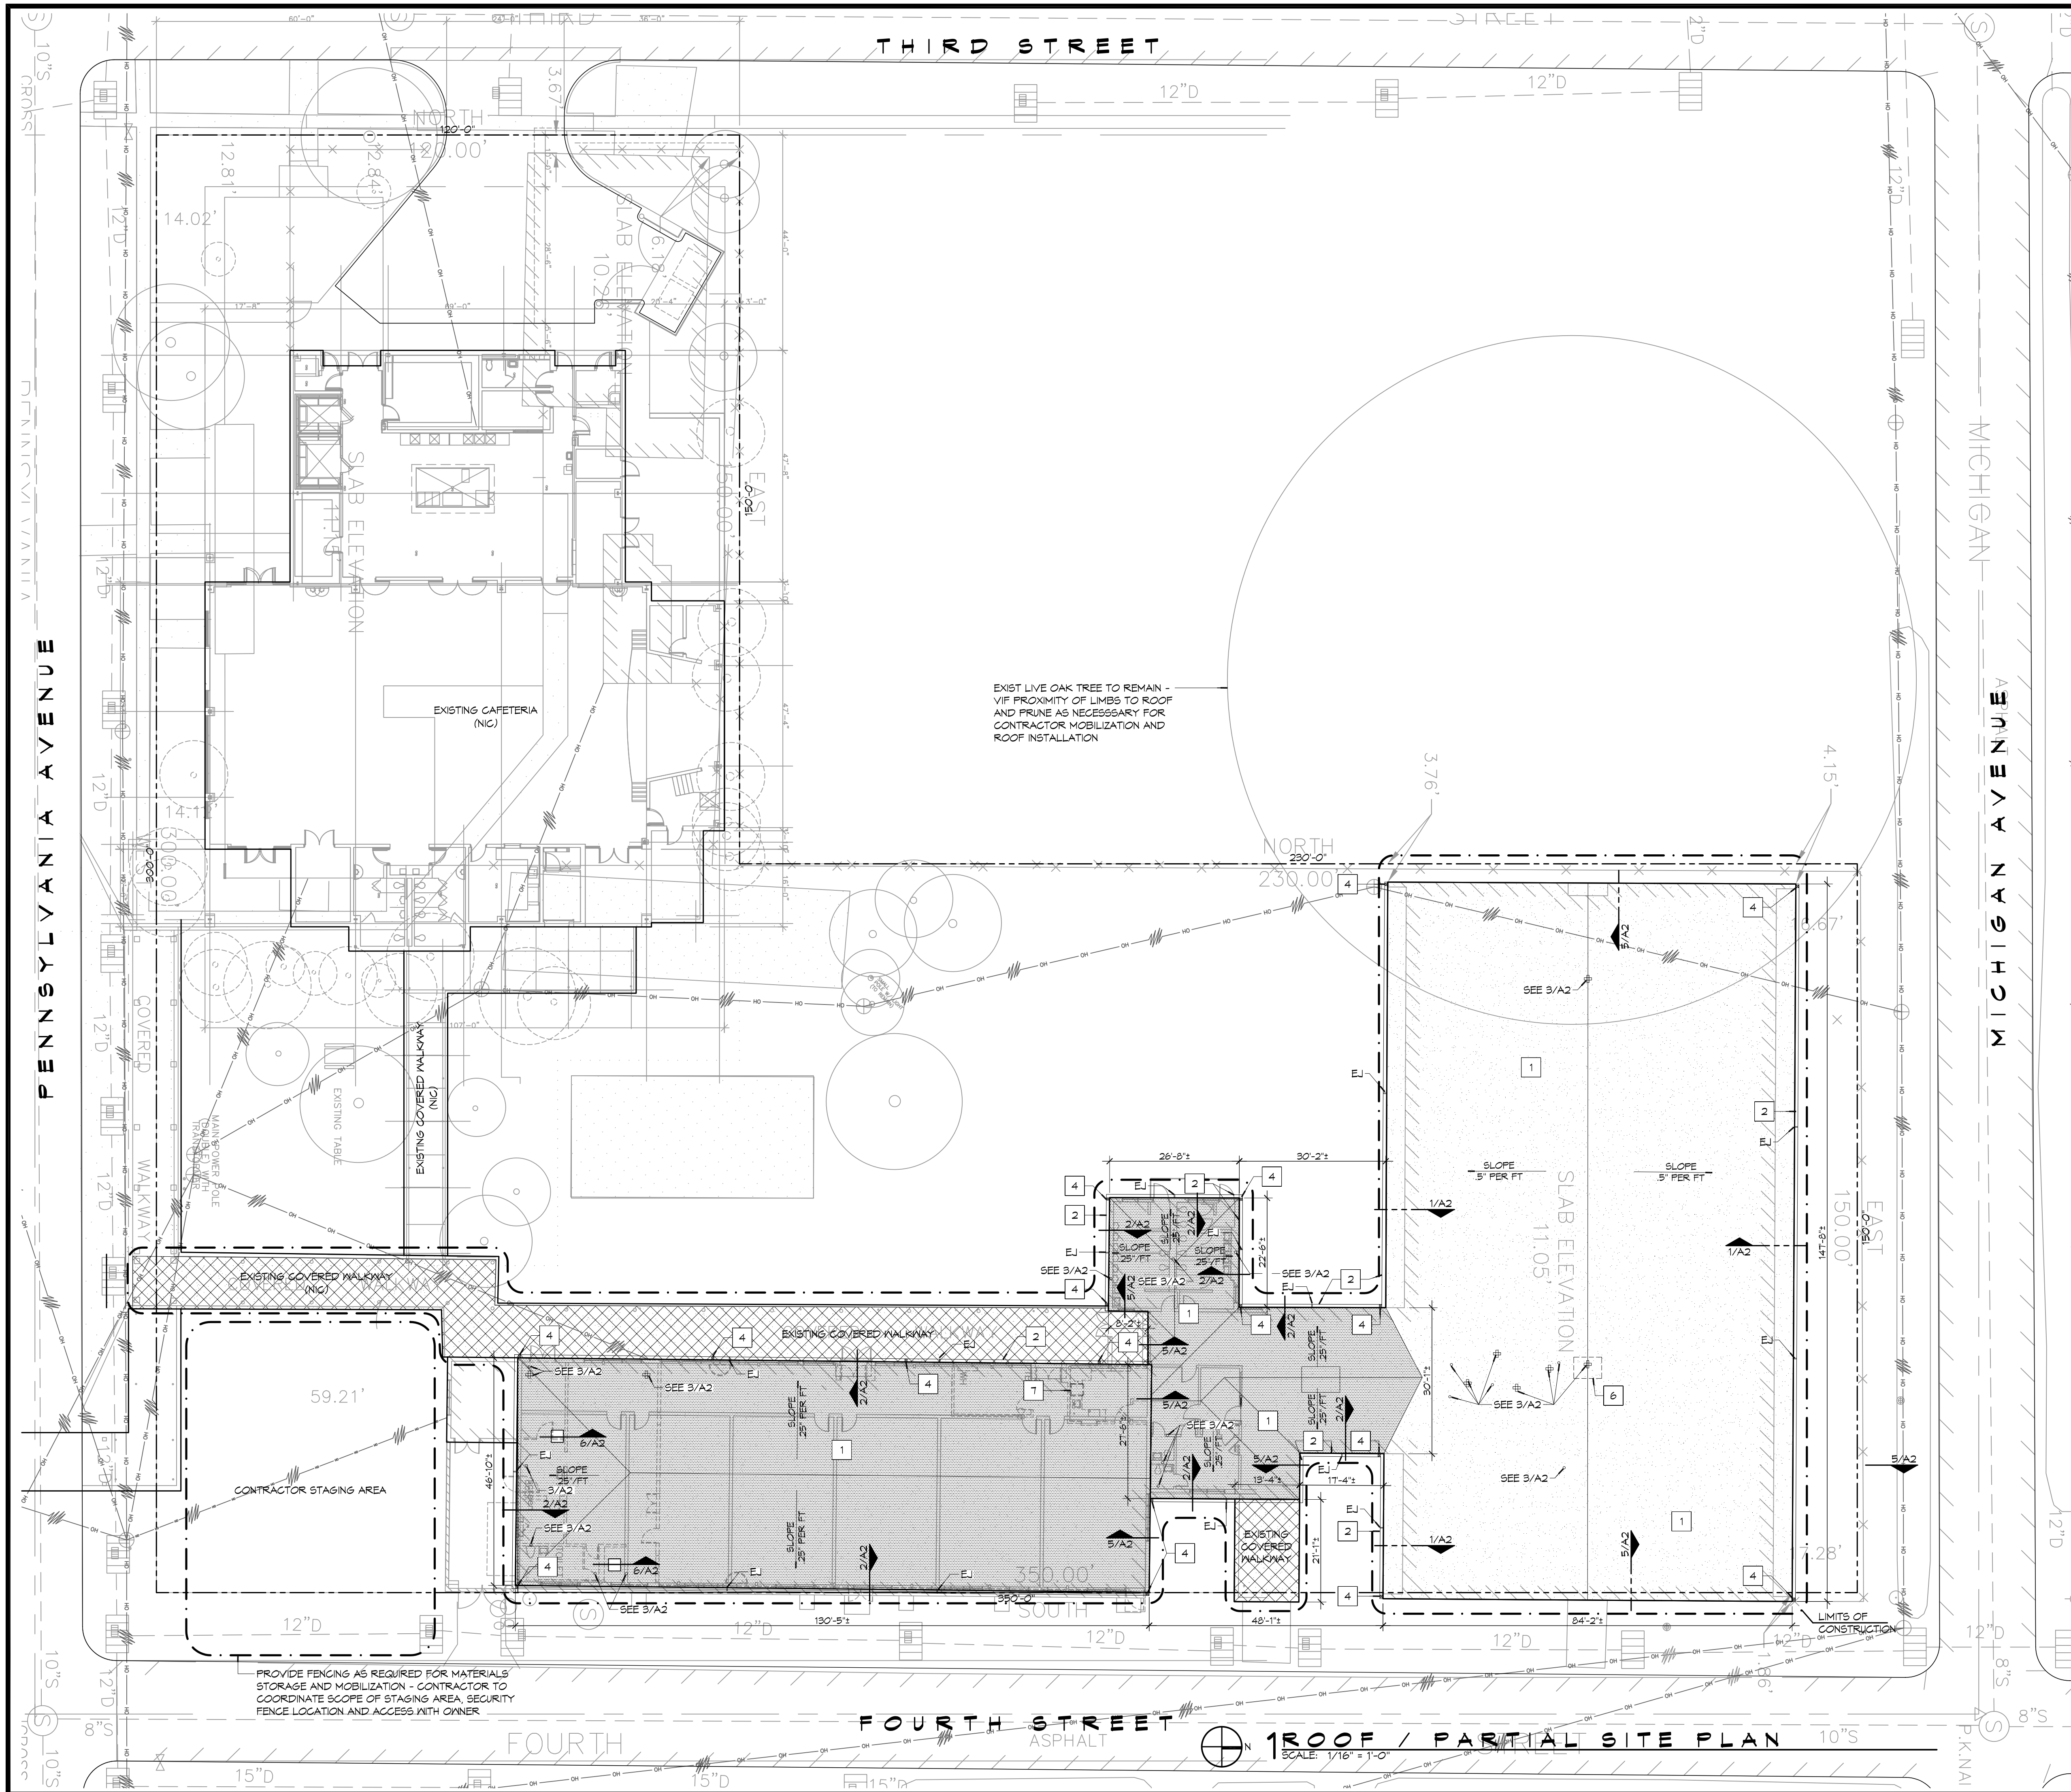
SEAL:

**REEROOFING OF OLD 6TH GRADE WING:
 SLIDELL HIGH SCHOOL**
 989 PENNSYLVANIA AVENUE ST. TAMMANY SCHOOL BOARD
 SLIDELL, LA 70458 PROJECT # 1521
 JOB NO: 2191 DATE: MARCH 9, 2014
 DRAWN BY: KJK CHECKED BY: KJK

SHEET TITLE:
ROOF DEMOLITION PLAN

DRAWING NUMBER:
D1
 SHEET NO: 3 OF 5

1 ROOF DEMOLITION PLAN
 SCALE: 1/16" = 1'-0"



ROOF NOTES

1. ALL DIMENSIONS OF EXIST CONDITIONS ARE APPROXIMATE AND SHOULD BE VERIFIED IN FIELD.
2. GENERAL ROOF SLOPE: 1/4" PER FOOT UNLESS NOTED OTHERWISE.
3. MTL GUTTERS SHALL HAVE EXPANSION JOINTS SPACED NOT TO EXCEED 50'.
4. PROVIDE CONG SPLASH BLOCKS WHERE EACH DOWNSPOUT TERMINATES AT GRADE OR ROOF BELOW.
5. ALL NEW MTL GUTTERS TO HAVE EXPANSION JOINTS WITH A SPACING NOT TO EXCEED 50'-0". SEE 8/A2 FOR EXP JT ASSEMBLY DETAIL.

LEGEND

- [Pattern 1] NEW MODIFIED BITUMEN ROOF MEMBRANE SYSTEM WITH 2 1/2" POLYISOCYANURATE INSULATION BOARD INFILL
- [Pattern 2] NEW MODIFIED BITUMEN ROOF MEMBRANE SYSTEM WITH TAPERED POLYISOCYANURATE INSULATION BOARD INFILL
- [Pattern 3] EXIST MODIFIED BITUMEN ROOF MEMBRANE WITH NEW PARACOAAT ROOF COATING
- [Symbol] EXIST OVERHEAD (OH) ELEC WIRES. CONTRACTOR TO FIELD VERIFY CLEARANCES WHERE NECESSARY TO CONDUCT WORK.

KEYNOTES


MK	DESCRIPTION
1	NEW SBS MODIFIED BITUMEN ROOF SYSTEM. SEE LEGEND ABOVE FOR INSULATION SUBSTRATE INFORMATION.
2	NEW PRE-FINISHED MTL GUTTER. SEE SHEET A2 FOR DETAILS AND 1/A2 FOR GUTTER PROFILE.
3	GUTTER EXPANSION JOINT. SEE 8/A2 FOR ASSEMBLY DETAIL.
4	NEW PRE-FINISHED 6"x6" MTL DOWNSPOUT. D/S PROFILE TO MATCH SMACNA MANUAL FIG. 1-32B. SET D/S 1/2" AWAY FROM WALL AND PROVIDE HANGERS (16GA X1") SPACED NOT MORE THAN 10'-0" OC. HANGER CONFIGURATION TO COMPLY WITH SMACNA MANUAL FIG. 1-35A.
5	EXIST MTL CURBS AND CAP FLASHING TO REMAIN. CONTRACTOR TO VERIFY CURB HEIGHT AND COORDINATE WITH INSUL INFILL TO MEET ROOFING MEMBRANE MFR REQUIREMENTS.
6	REPAIR EXIST ROOF DECK DAMAGE WITH 2 1/2" GYPSUM CONG PATCH. SCOPE OF DAMAGE APPROX 12 SF. CONTRACTOR TO FIELD VERIFY SCOPE OF NEEDED REPAIRS AND REPORT TO ARCHITECT.

SITE NOTES

1. CONTRACTOR SHALL BE RESPONSIBLE FOR REPAIR TO EXIST BUILDING/SITE ELEMENTS PRIOR TO THE RESUMPTION OF SCHOOL SCHEDULE.
2. PEDESTRIAN ACCESS TO BUILDING ENTRANCE AT FOURTH STREET IS TO BE MAINTAINED AT ALL TIMES.

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REEROOFING OF OLD 6TH GRADE WING:
LINDELL HIGH SCHOOL
 ST. TAMMANY SCHOOL BOARD
 989 PENNSYLVANIA AVENUE
 SLIDELL, LA 70458
 PROJECT # 1521
 JOB NO: 2181 DATE: MARCH 9, 2014
 DRAWN BY: K-K CHECKED BY: K-K

SHEET TITLE:
ROOF PLAN

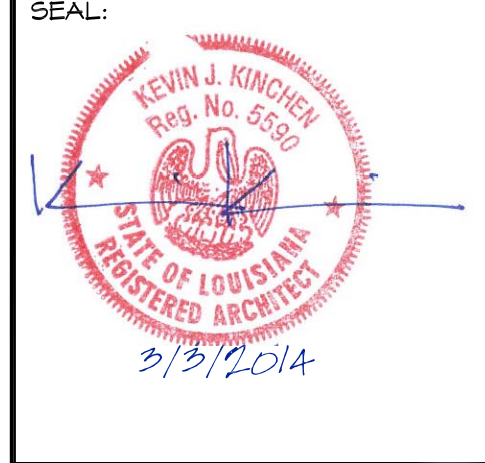DRAWING NUMBER:
A1

SHEET NO: 2 OF 5

GENERAL NOTES

- ITEMS INDICATED IN GRAY POCHES ARE EXIST ELEMENTS TO REMAIN. ACTUAL ELEMENTS MAY VARY BY LOCATION. CONTRACTOR TO VERIFY EXIST CONDITIONS AND MAKE ADJUSTMENTS TO DETAILS AS NECESSARY IN CONFORMANCE WITH ROOFING MANUFACTURER'S RECOMMENDATION.
- SIPLAST SBS MODIFIED BITUMEN MEMBRANE SYSTEM IS USED AS A BASIS OF DESIGN FOR THESE DETAILS AND SPECIFIC MATERIALS NAMED REFER TO THIS SYSTEM. ACTUAL MATERIALS MAY VARY SHOULD A DIFFERENT APPROVED ROOF MEMBRANE SYSTEM BE USED.

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Chief Architect: Kevin J. Kinchen, NCARB
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**REEROOFING OF OLD 6TH GRADE WING:
LINDERL HIGH SCHOOL**

ST. TAMMANY SCHOOL BOARD
PROJECT # 1921


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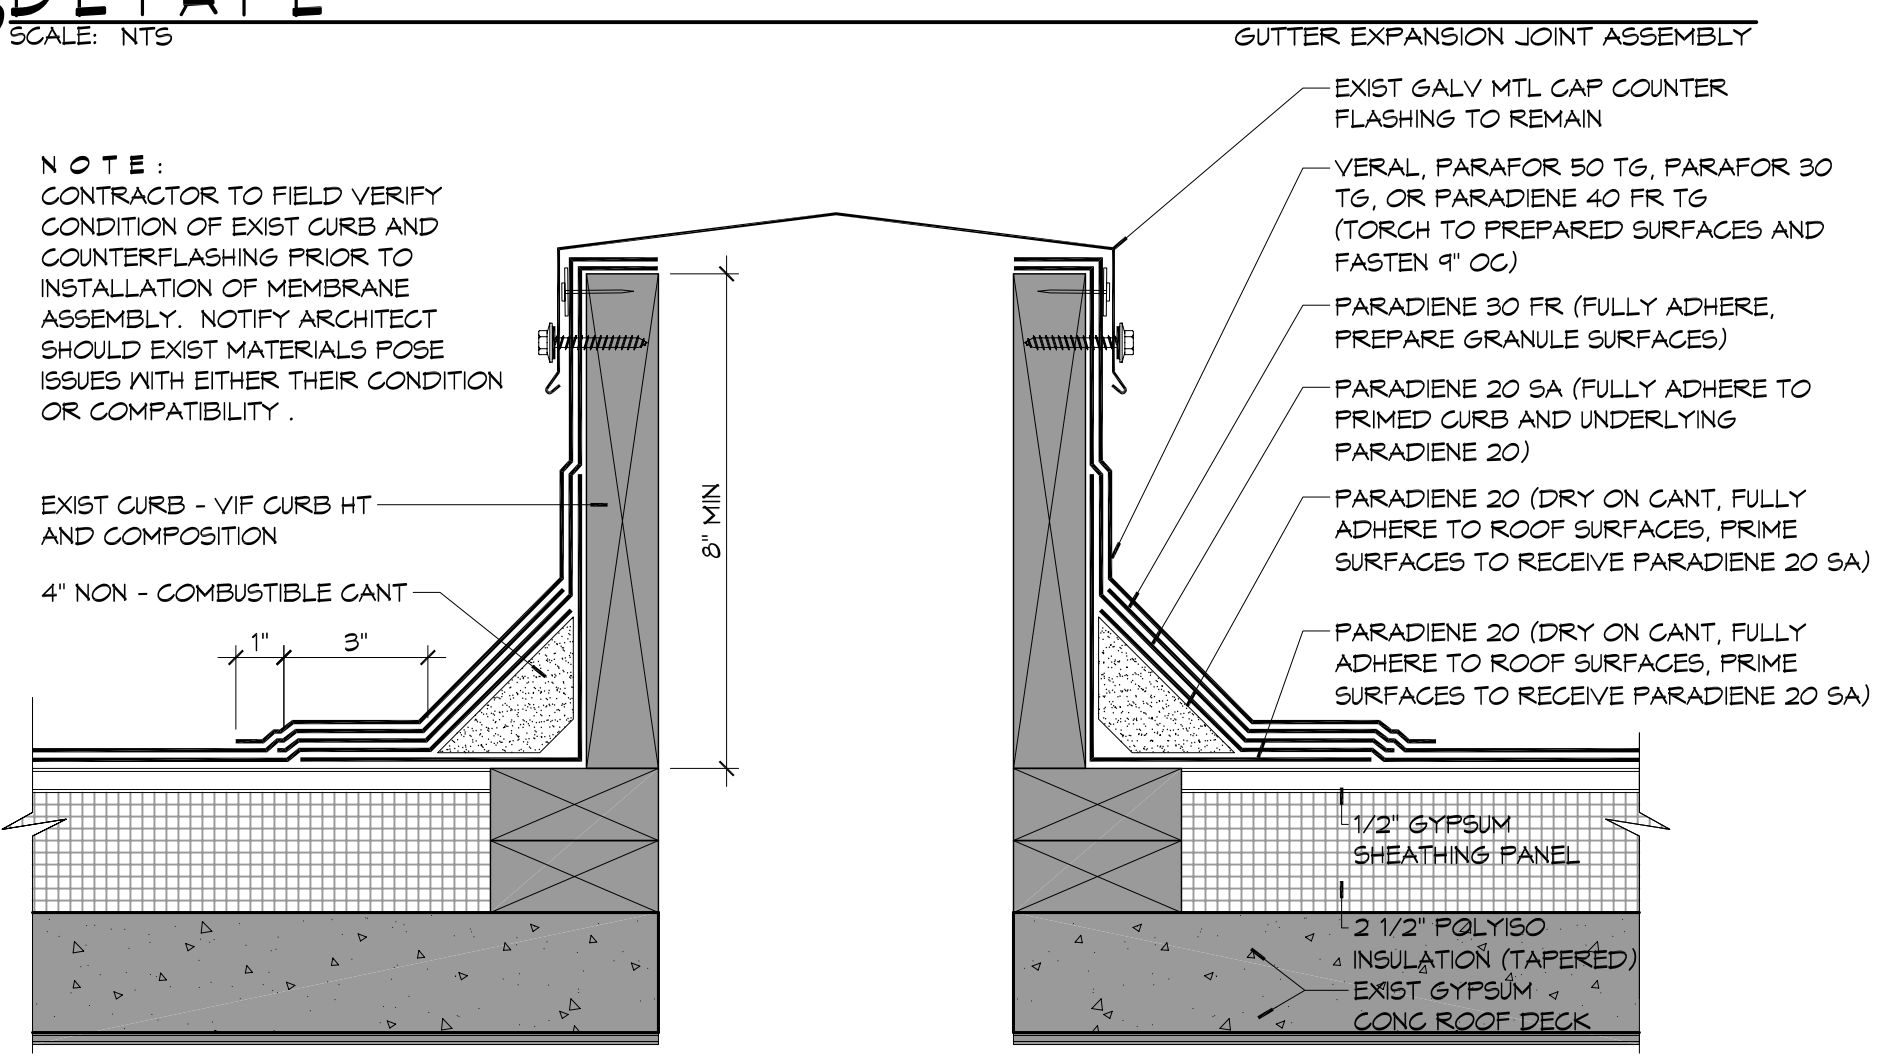
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ROOF DETAILS

DRAWING NUMBER:
A2


SHEET No: 5 of 5




8 DETAIL
SCALE: NTS

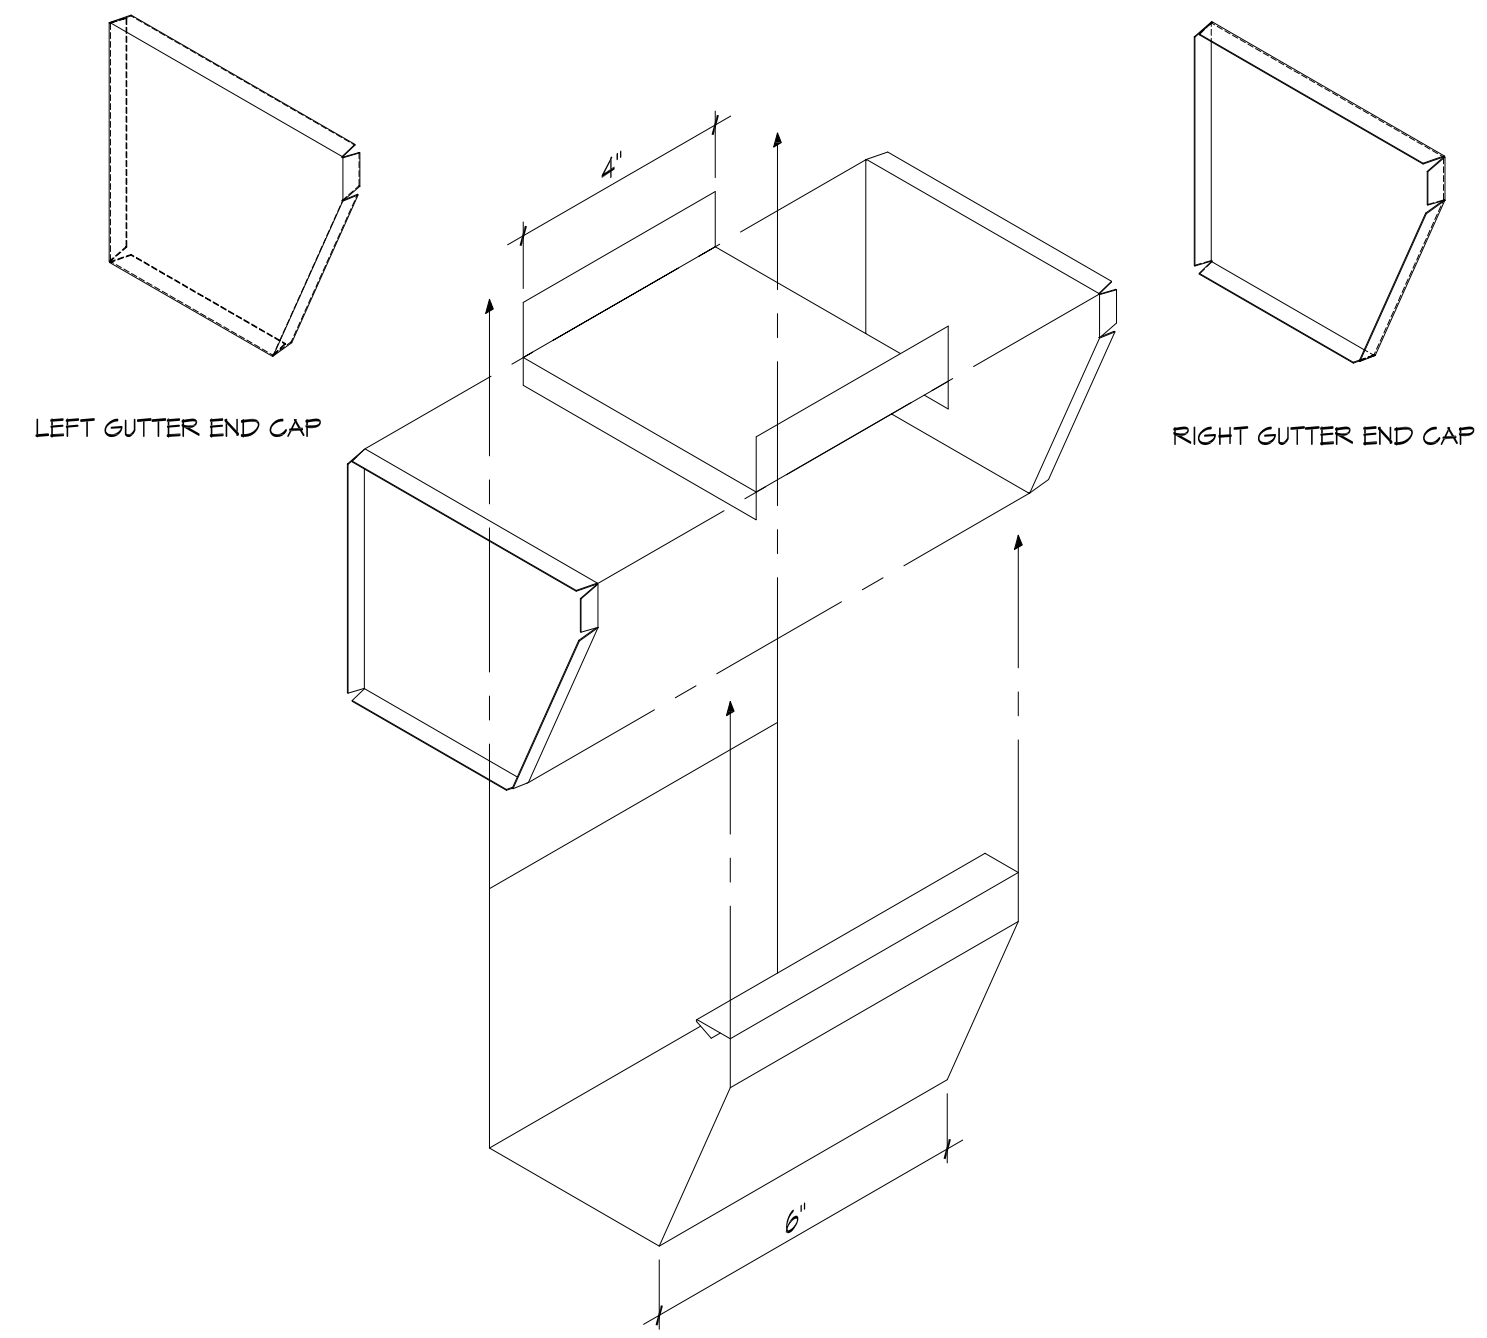


6 ROOF DETAIL
SCALE: 3" = 1'-0"

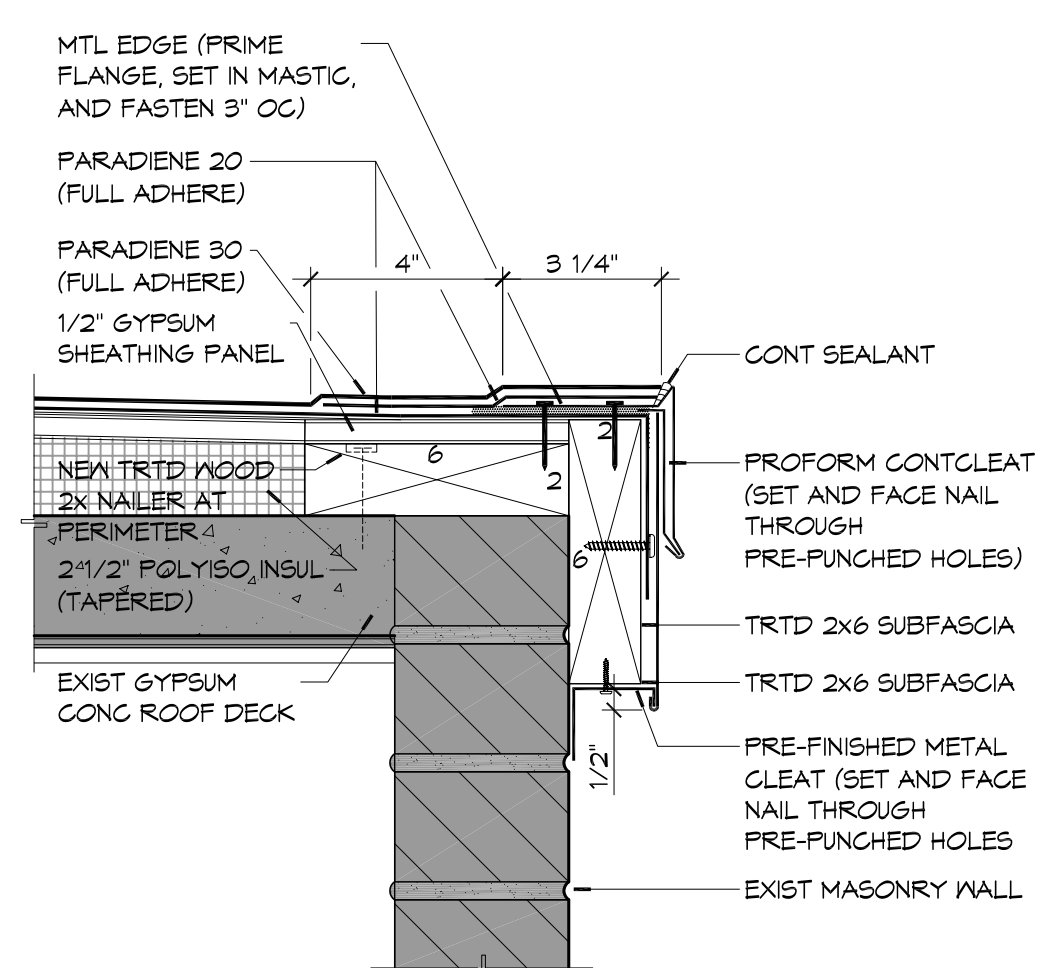


5 ROOF DETAIL
SCALE: 3" = 1'-0"

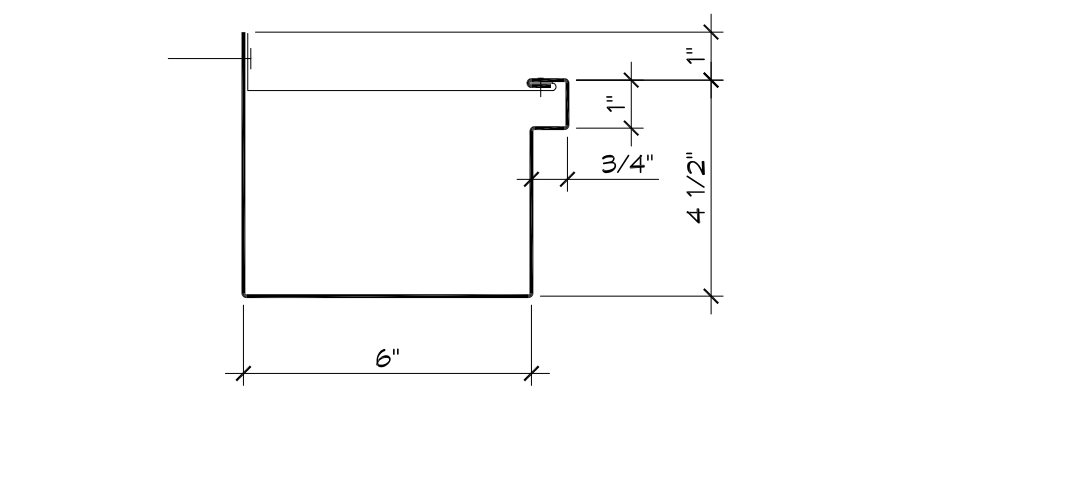


7 DETAIL
SCALE: 3" = 1'-0"

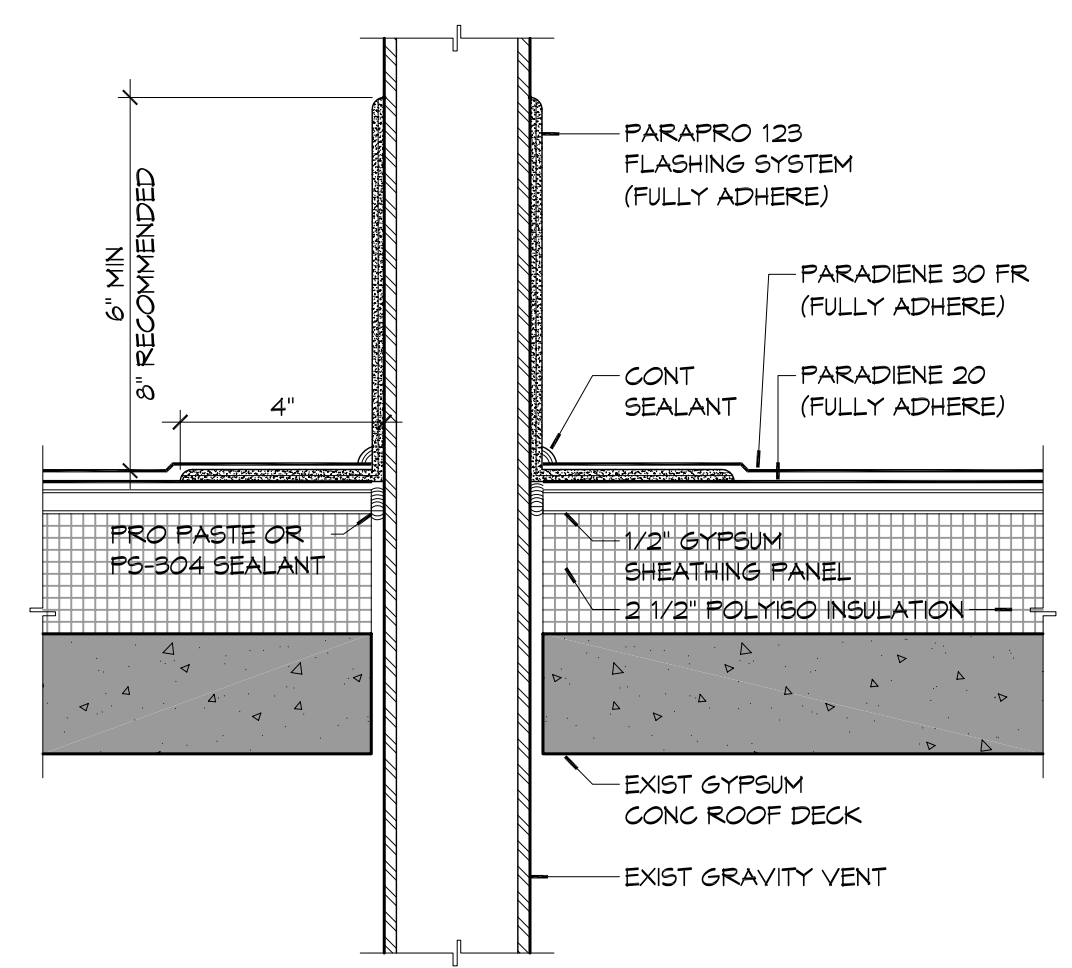


3 ROOF DETAIL
SCALE: 3" = 1'-0"

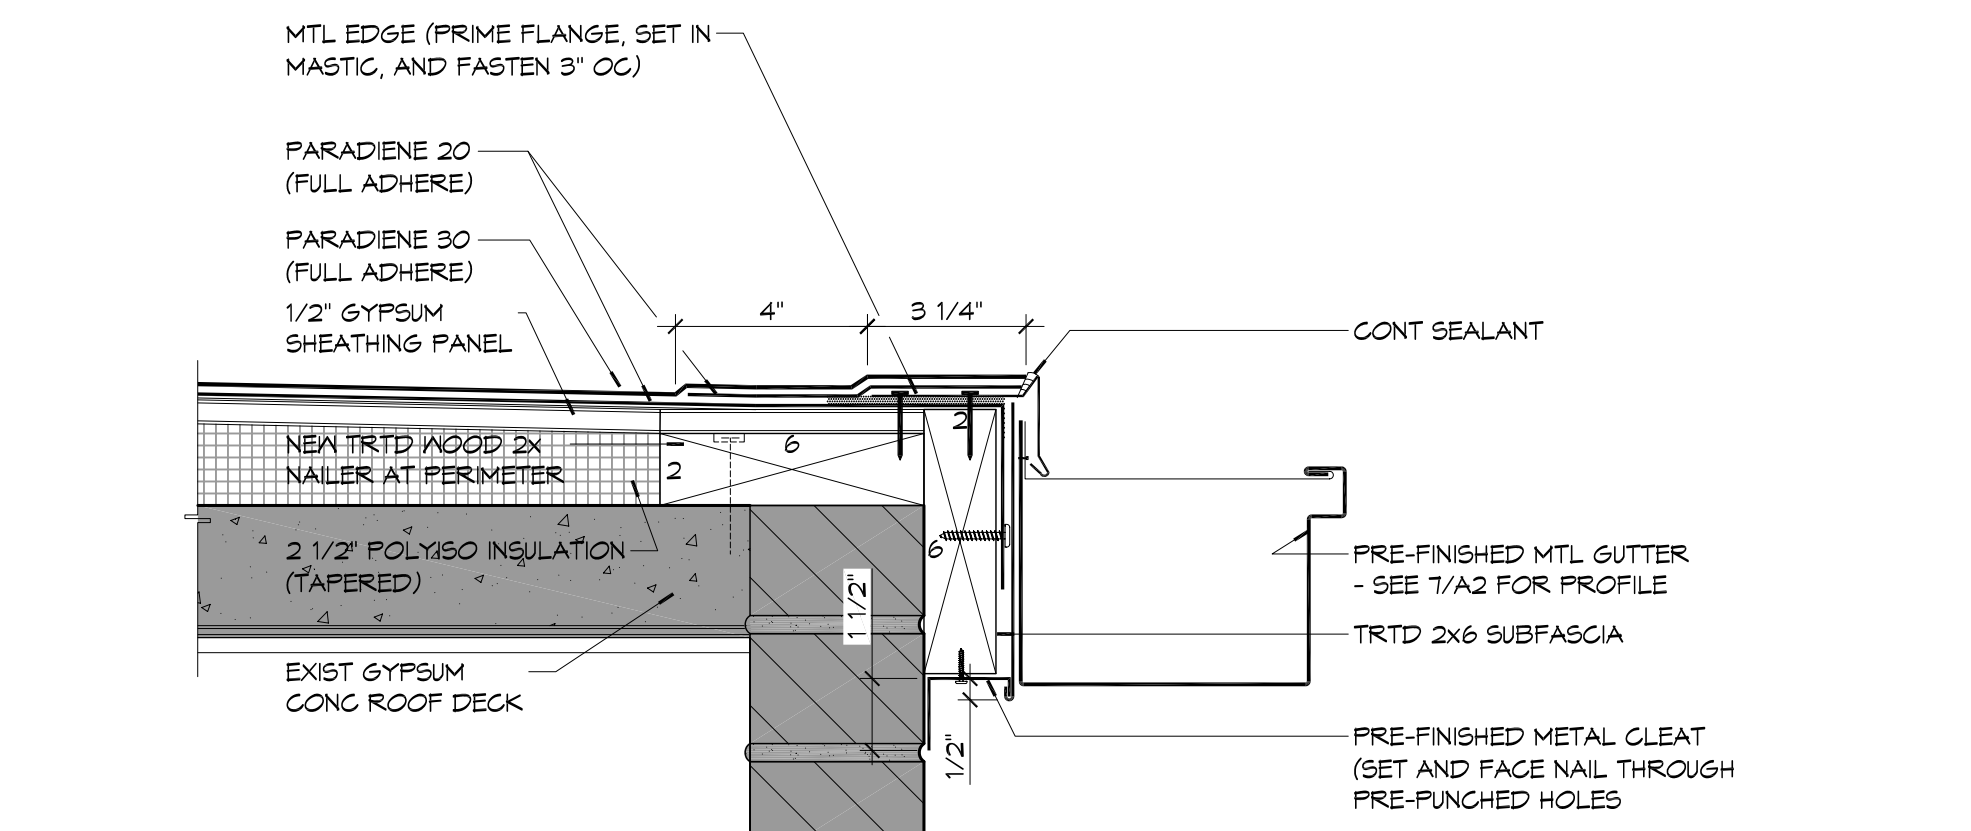

2 ROOF DETAIL
SCALE: 3" = 1'-0"

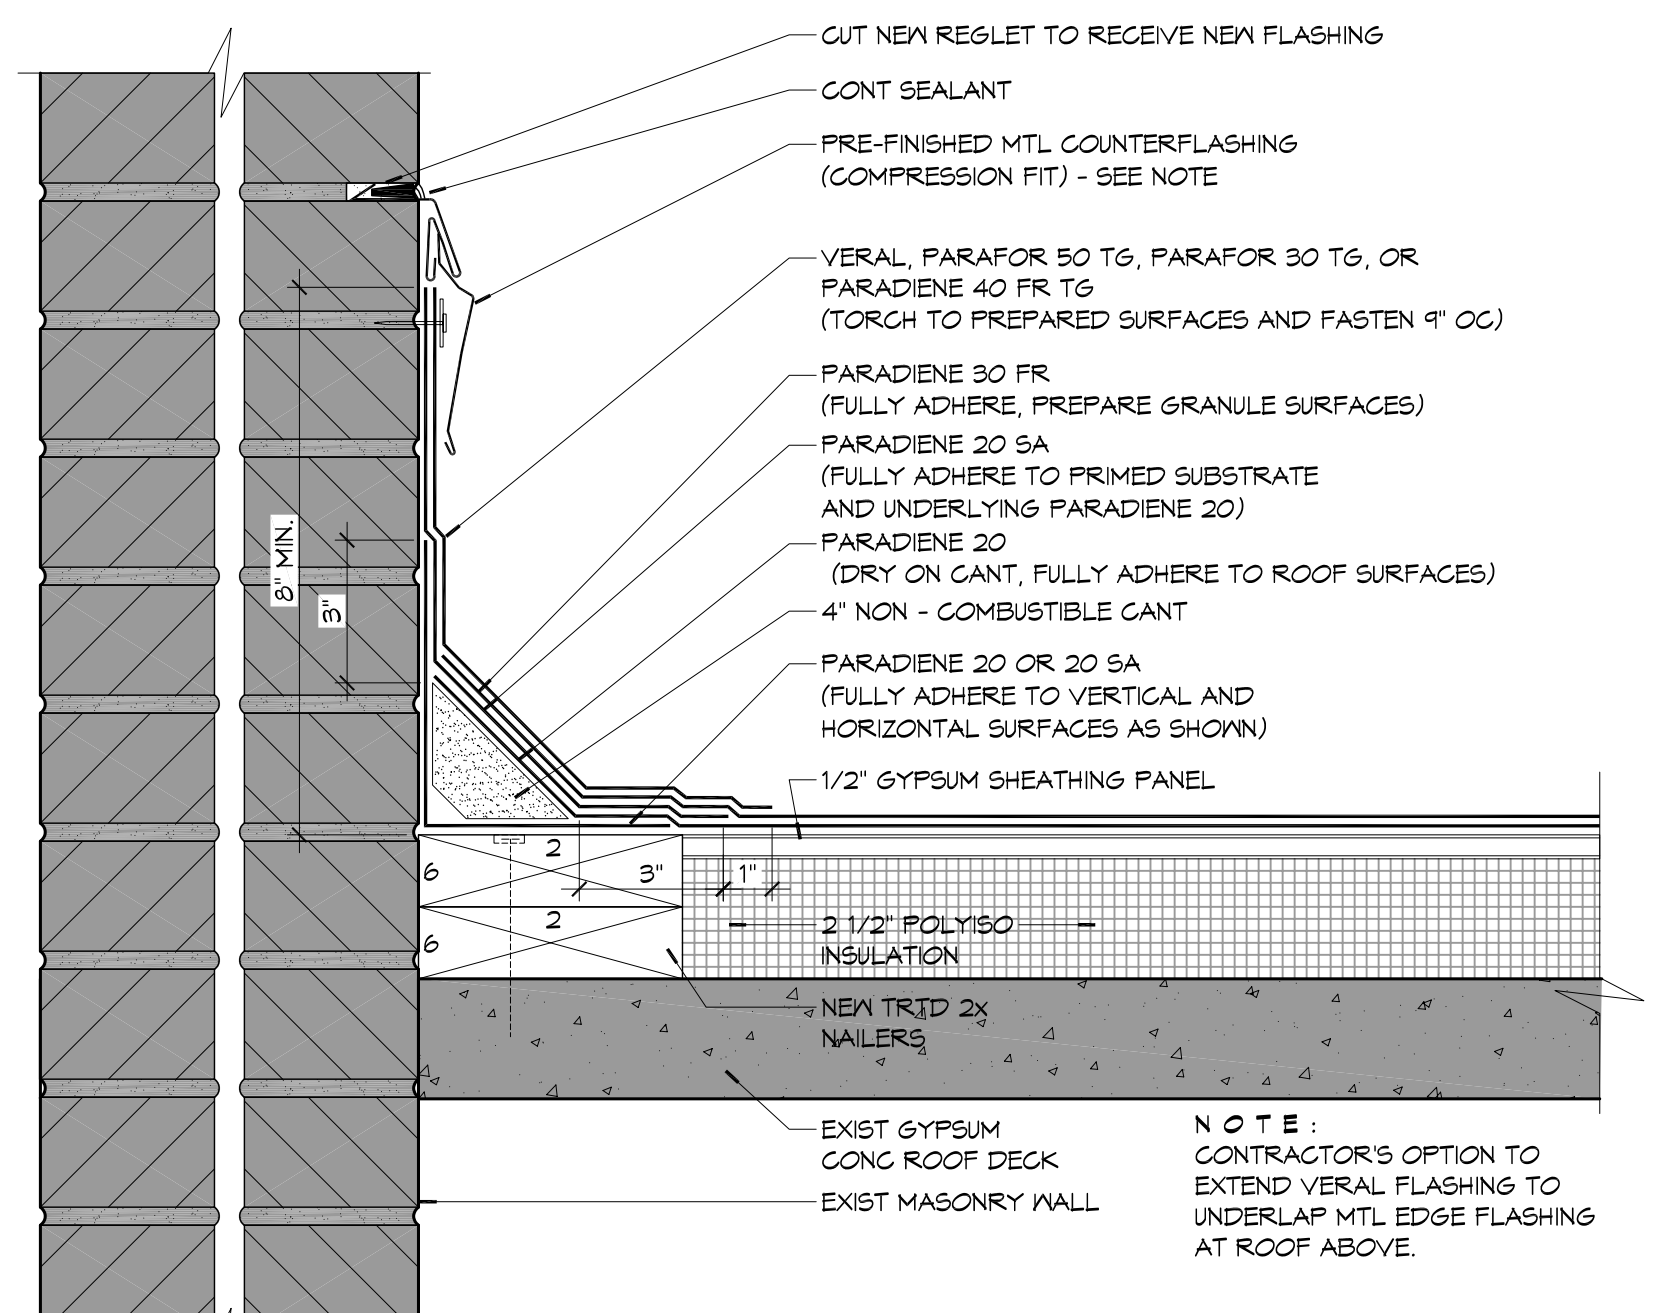

4 ROOF DETAIL
SCALE: 3" = 1'-0"

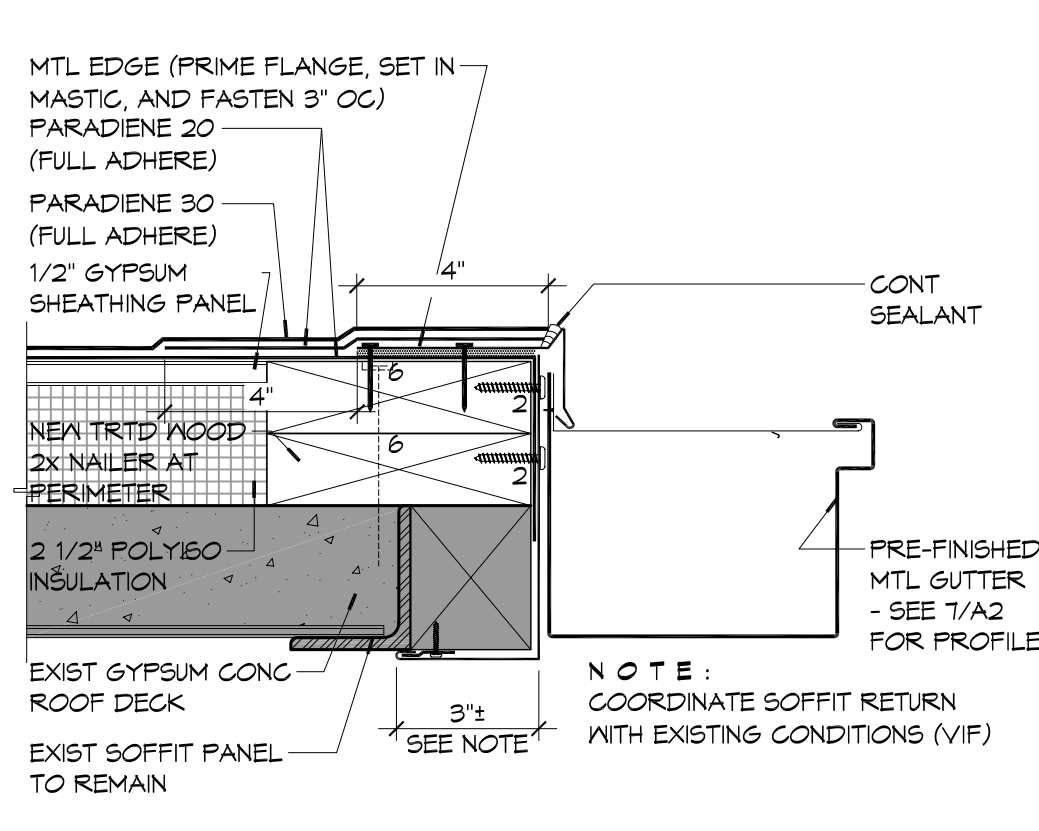

1 ROOF DETAIL
SCALE: 3" = 1'-0"