

LIFE-SAFETY INFORMATION

APPLICABLE CODES	NFPA 101 LIFE-SAFETY CODE 2012
OCCUPANCY TYPE(S) AND CHAPTER(S)	ASSEMBLY (REFERENCE CHAPTER 6.12)
OCCUPANT LOAD FACTOR	3165 SF PER OCCUPANT (NET)
ASSEMBLY (NET)	211 OCCUPANTS
KITCHEN (GROSS)	3336 SF PER OCCUPANT
KITCHEN (GROSS)	3336 SF PER OCCUPANT
CLASSIFICATION OF HAZARD OF CONTENTS	(REFERENCE CHAPTER AND 6.2.2 SPECIFY LOW, ORDINARY, OR HIGH)
CONSTRUCTION TYPE(S)	(REFERENCE CHAPTER 6, TABLE A.6.2.1.2 AND COMMENTARY TABLE B.1 IN HANDBOOK)
MINIMUM EXIT SEPARATION DISTANCE FOR REMOTELY LOCATED EXITS	(REFERENCE SECTION 7.5, SPECIFY 1/2 OR 1/3 DIAGONAL DISTANCE OF AREA SERVED)
1/2 DIAGONAL =	75'-10"
MAXIMUM COMMON PATH OF TRAVEL DISTANCE	(REFERENCE OCCUPANCY CHAPTER AND TABLE A.16)
ASSEMBLY = 20 FT	(REFERENCE OCCUPANCY CHAPTER AND TABLE A.16)
MAXIMUM DEAD-END CORRIDOR DISTANCE	(REFERENCE OCCUPANCY CHAPTER AND TABLE A.16)
ASSEMBLY = 20 FT	(REFERENCE OCCUPANCY CHAPTER AND TABLE A.16)
MAXIMUM TRAVEL DISTANCE TO EXITS	(REFERENCE OCCUPANCY CHAPTER AND TABLE A.16)
ASSEMBLY = 200 FT	(REFERENCE OCCUPANCY CHAPTER AND TABLE A.16)
EXTINGUISHMENT REQUIREMENTS	NOT SPRINKLED (NOT REQUIRED)
DETECTION, ALARM, AND COMMUNICATION SYSTEMS	NOT REQUIRED
ALLOWABLE HEIGHT AND BUILDING AREA	PER IBC EQUIVALENT CONSTRUCTION TYPE

BUILDING CODE INFORMATION

APPLICABLE CODES: IBC 2012	CHAPTER 9, USE AND OCCUPANCY CLASSIFICATION
ASSEMBLY A2	RESTAURANTS, CATERING AND SIMILAR DINING FACILITIES SECTION 909.9
OCCUPANT LOAD	(TABLE 1004.4 & 1004.1.2)
FIXED SEATING / TABLE AND CHAIRS	15 SF PER OCCUPANT (NET)
KITCHEN, COMMERCIAL	200 SF PER OCCUPANT (GROSS) 3336 S.F. (GROSS) 17 OCCUPANTS
CONSTRUCTION TYPE(S)	(TABLE 603)
ALLOWABLE HEIGHT AND BUILDING AREA LIMITED BY TYPE OF CONSTRUCTION	
GROUP	MAXIMUM HEIGHT IN STORES 4500
A2	MINIMUM HEIGHT 9'-0"

WIND SPEED DESIGN REQUIREMENTS

THIS BUILDING SHALL BE DESIGNED WITH IBC SEC 1609.6 A FULLY ENCLOSED BLDG USING THE FOLLOWING INFORMATION:

WIND DESIGN DATA:


DETERMINATION OF WIND LOADS SHALL BE IN ACCORDANCE WITH IBC SEC 1603.1 (A), (B), OR (C) DEPENDING ON THE RISK CATEGORY

V ULTIMATE WIND SPEED (S SECOND 6.97) =	130 MPH (IBC FIG. 1603C)
V NOMINAL WIND SPEED (60/3.1)	101 MPH
RISK FACTOR (CATEGORY II BLDG)	C
TOPOGRAPHIC EXPOSURE =	C
DESIGN WIND PRESSURE (ASCE 7-10 TABLE 28.6-1):	47.5 PSF
INTERNAL PRESSURE COEFFICIENT (ASCE 7-10 TABLE 28.11-1):	+ 0.18
LIVE LOADS (IBC SEC. 1607):	50 PSF
OFFICE (IBC TABLE 1607.1):	100 PSF
OFFICE LOBBY (IBC TABLE 1607.1):	100 PSF
CORRIDORS 1ST FLOOR	250 PSF
STORAGE WAREHOUSE	100 PSF & 1,000 LBS CONCENTRATED
RETAIL STORES 1ST FLOOR	20 PSF & 300 LB CONCENTRATED
ROOF LIVE LOADS (IBC TABLE 1607.1):	20 PSF & 300 LB CONCENTRATED
GROUND SNOW LOAD (IBC FIG. 1608.2):	5 PSF

FLOOD ZONE INFORMATION

F.R.M. COMMUNITY MAP NO 22051C 0155 E, REVISED 3/23/1995	
FLOOD ZONE:	AE
BASE FLOOD ELEVATION:	3.5 NGVD
ELEVATIONS REFER TO NGVD 1929 DATUM	

**EL PASO MEXICAN RESTAURANT
RENOVATION
OF AN EXISTING RESTAURANT**

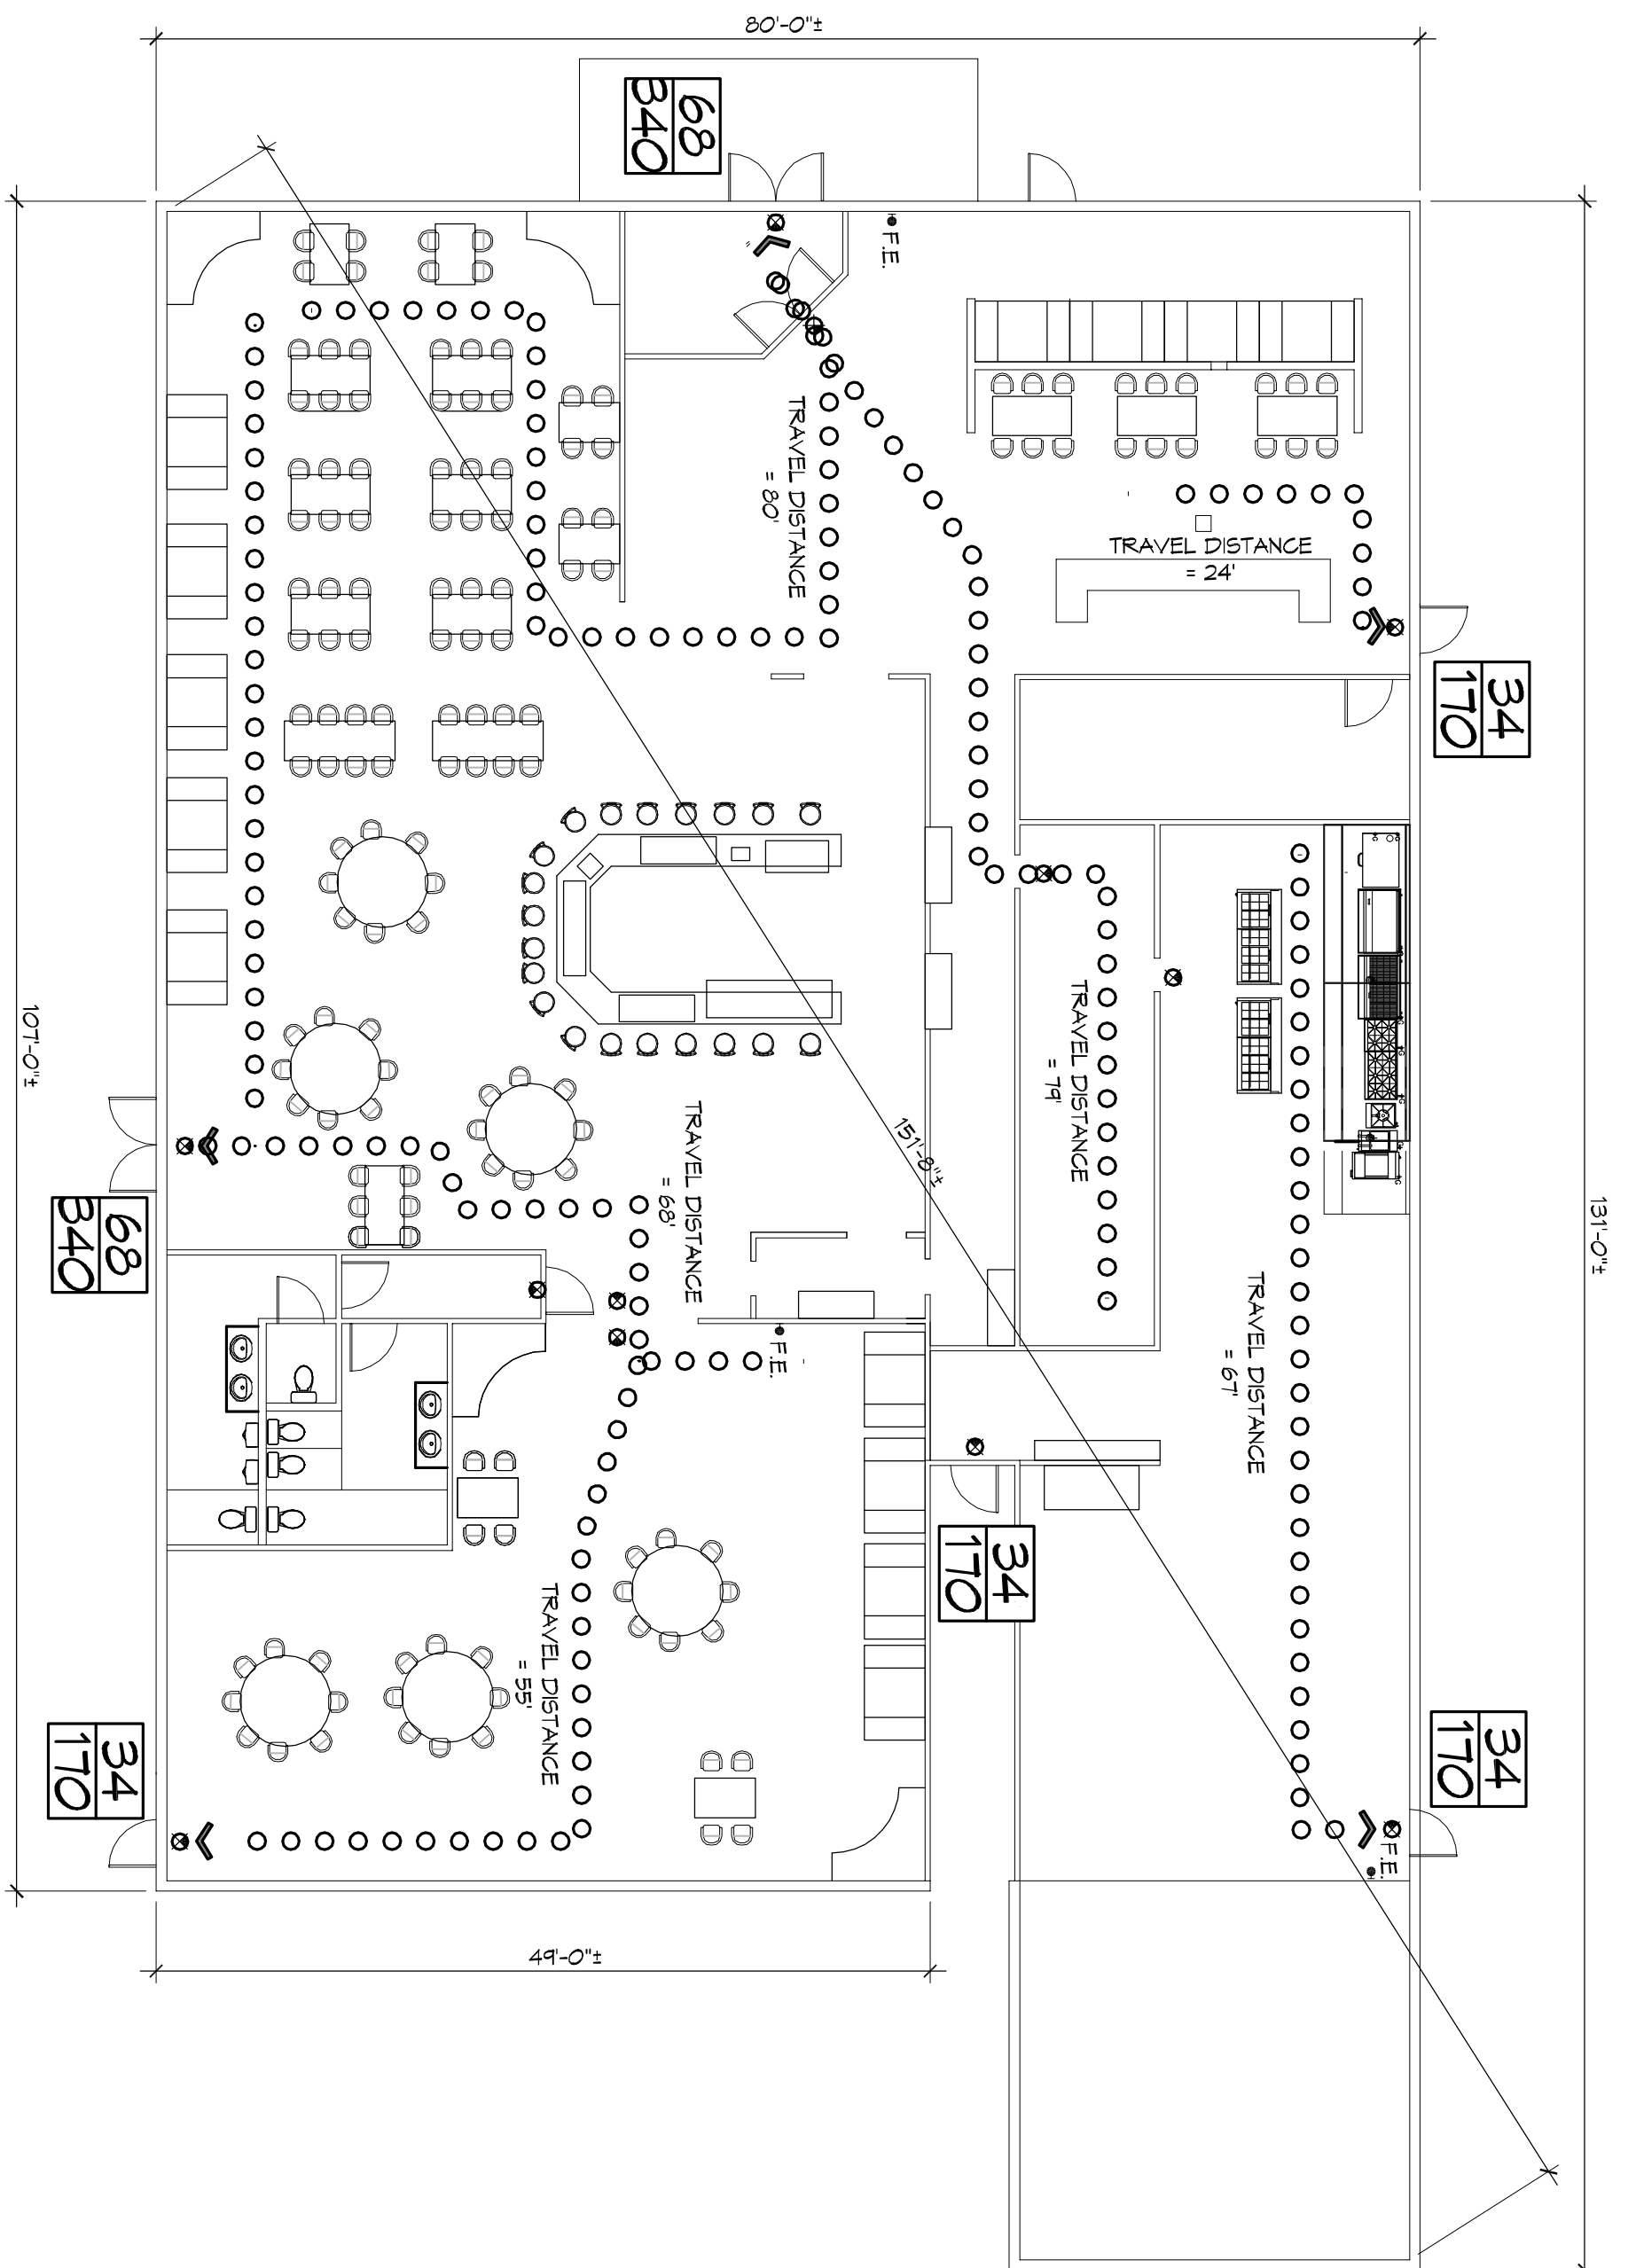

LIFE-SAFETY LEGEND

SYMBOL	DESCRIPTION
➤	EXITS
⊙	EXIT LIGHT
⋯	TRAVEL DISTANCE
⦿	FIRE EXTINGUISHER W/ WALL MTD BRACKET
⊠	DOOR WIDTH/CAPACITY

VICINITY MAP

LIFE-SAFETY PLAN

SCALE: 3/32" = 1'-0"



SHEET INDEX

SHEET #	SHEET TITLE
0001	GENERAL INFORMATION SHEET
0100	EXISTING SITE PLAN & PARKING
A101	ARCHITECTURAL FLOOR PLAN, PLUMBING & ELECTRICAL
A102	FRONT PORCH PARAPET DETAILS & REAR PARAPET DETAILS

PROJECT STATISTICS

EXISTING SQUARE FOOTAGE	4041 SF PER FLOOR
-------------------------	-------------------

PROJECT LOCATION

601 VETERANS BLVD, METAIRIE, LOUISIANA 70058
 CONTACT:
 REGISLDO CHAVEZ
 (504) 655-1649

DAMMON ENGINEERING, INC.
 LOUISIANA & MISSISSIPPI

Chief Engineer: Brian Mistich, PE
 554 Old Spanish Trail
 Slidell, LA 70458
 www.dammonengineering.com
 info@dammonengineering.com
 PH: 985.649.5832 F: 985.641.5950

REVISIONS

#	DESCRIPTION	DATE

GENERAL INFORMATION SHEET

SHEET TITLE: 601 VETERANS BLVD, METAIRIE, LOUISIANA

JOB No: 2266 DATE:

DRAWN BY: CKD CHECKED BY: BAM

601 VETERANS BLVD, METAIRIE, LOUISIANA

DATE: 2266

DRAWN BY: CKD CHECKED BY: BAM

5001

1 of 4