



PILING & FOUNDATION PLAN
SCALE 1/8" = 1'-0"


SECTION A A

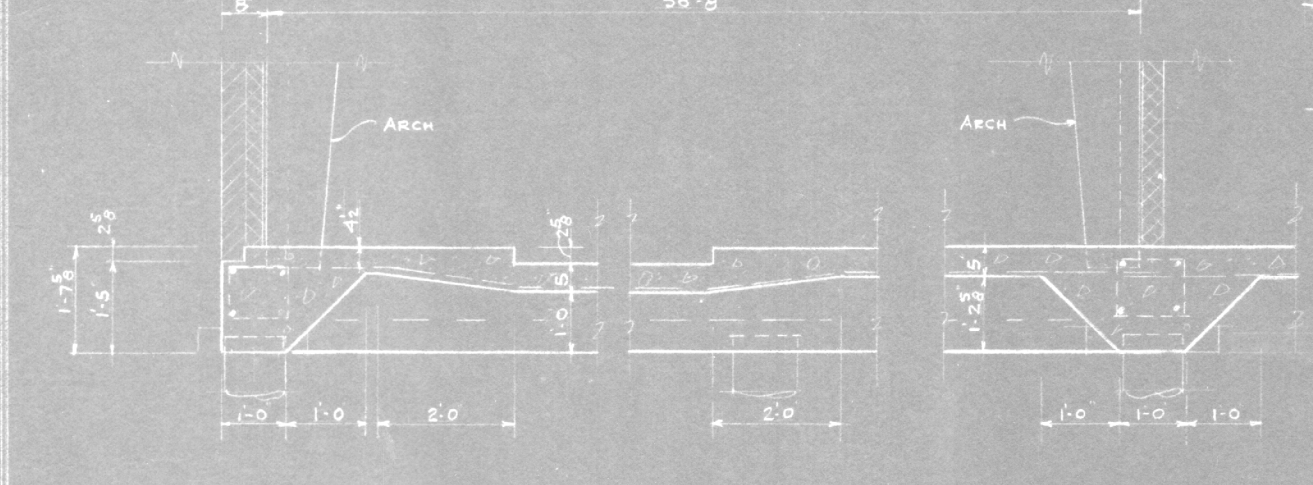

SECTION B B

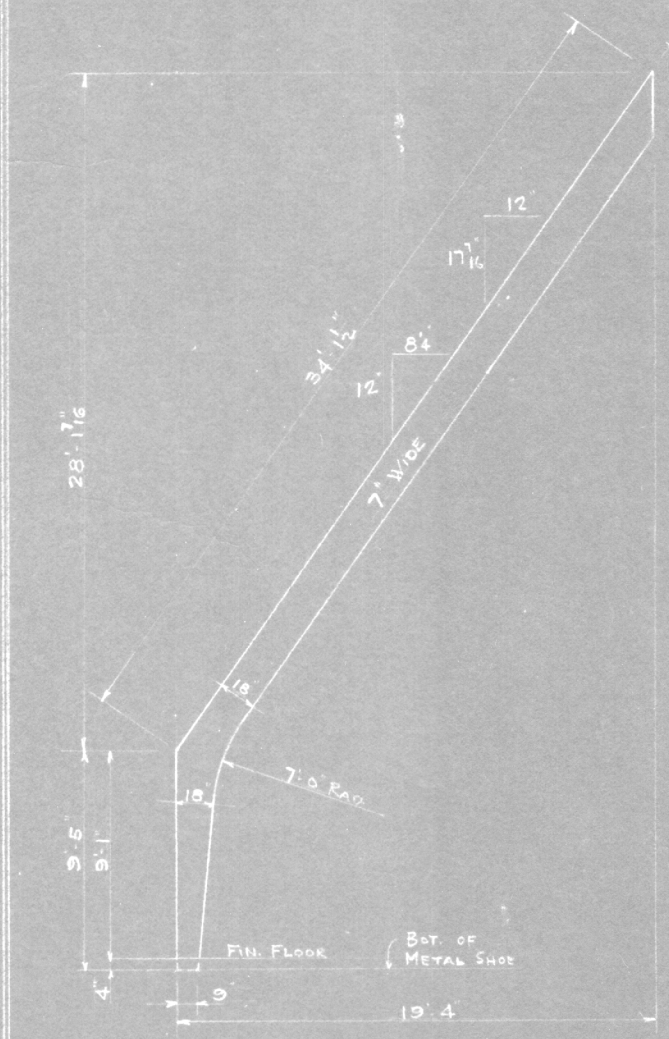


HALF ARCH
SCALE 3/16" = 1'-0"

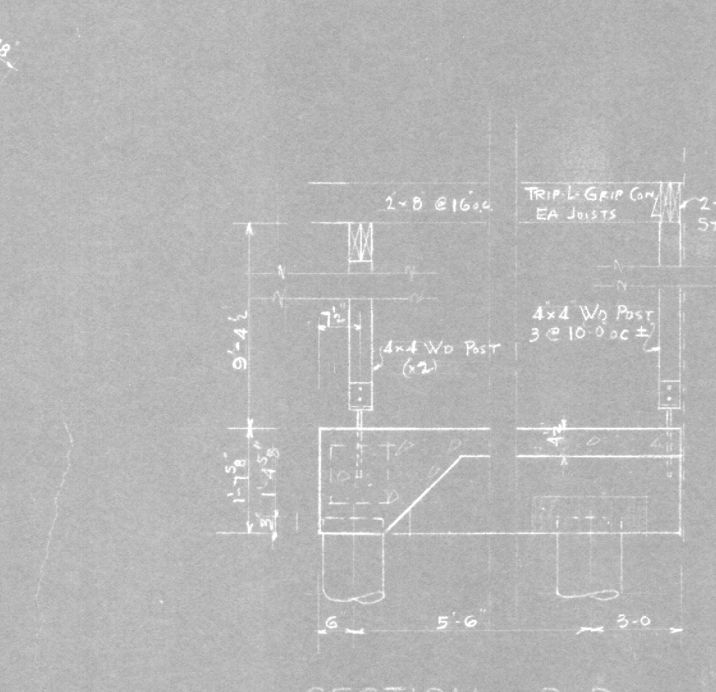


SECTION D D

TYPICAL PLATFORM

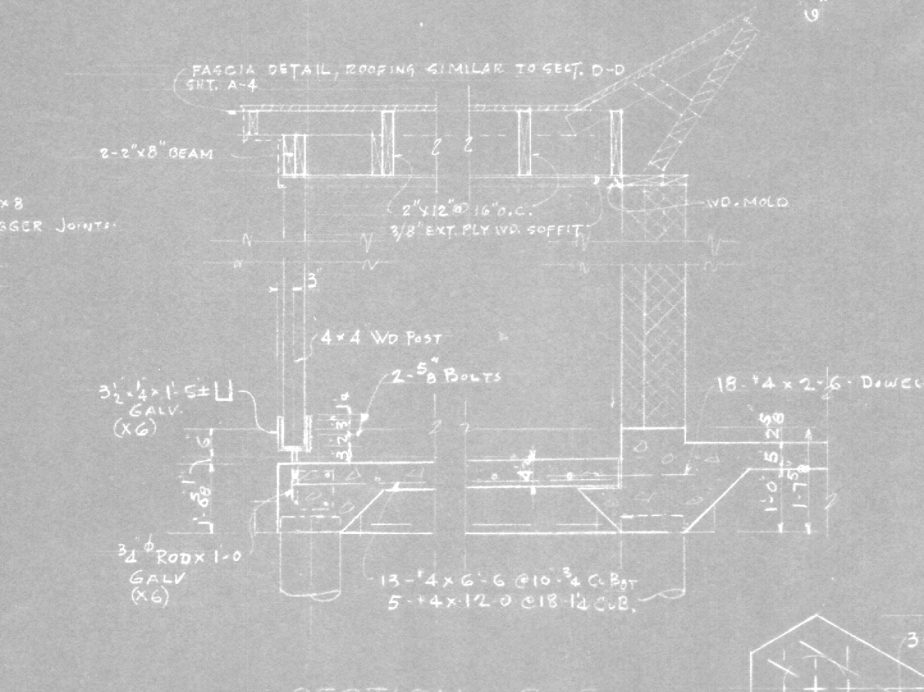

SECTION C C

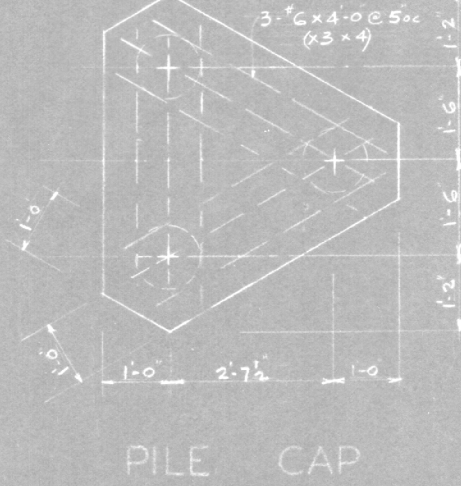


PILE CAP

GRADE BEAM SCHEDULE - REINFORCING STEEL

GRADE BEAM NO.	QUAN.	TOP BARS	BOTTOM BARS	TIES	POSITION	REMARKS			
		QUAN.	SIZE	LENGTH	QUAN.	SIZE	SPACING		
B1	3	1	#8	22'-0"	3	#5	17'-6"	#2	
B2	5	1	#8	22'-0"	3	#5	17'-6"	#2	
B3	5	1	#8	22'-0"	3	#5	17'-6"	#2	
B4	1	1	#8	22'-0"	3	#5	17'-6"	#2	
B5	1	1	#8	22'-0"	3	#5	17'-6"	#2	
B6	1	1	#8	22'-0"	3	#5	17'-6"	#2	
B7	1	1	#8	22'-0"	3	#5	17'-6"	#2	
B8	1	1	#8	22'-0"	3	#5	17'-6"	#2	
B9	1	1	#8	22'-0"	3	#5	17'-6"	#2	
B10	1	1	#8	22'-0"	3	#5	17'-6"	#2	
B11	1	1	#8	22'-0"	3	#5	17'-6"	#2	
B12	1	1	#8	22'-0"	3	#5	17'-6"	#2	
B13	1	1	#8	22'-0"	3	#5	17'-6"	#2	
B14	1	1	#8	22'-0"	3	#5	17'-6"	#2	
C1	1	1	#8	22'-0"	3	#5	17'-6"	#2	
C2	1	1	#8	22'-0"	3	#5	17'-6"	#2	
C3	1	1	#8	22'-0"	3	#5	17'-6"	#2	
C4	1	1	#8	22'-0"	3	#5	17'-6"	#2	
C5	1	1	#8	22'-0"	3	#5	17'-6"	#2	
C6	1	1	#8	22'-0"	3	#5	17'-6"	#2	
C7	1	1	#8	22'-0"	3	#5	17'-6"	#2	
C8	1	1	#8	22'-0"	3	#5	17'-6"	#2	
C9	1	1	#8	22'-0"	3	#5	17'-6"	#2	
C10	1	1	#8	22'-0"	3	#5	17'-6"	#2	
C11	1	1	#8	22'-0"	3	#5	17'-6"	#2	

PILING
QUAN. CAPACITY TYPE DIAMETER DEPTH
CONCRETE STRENGTH 2500 PSI

100 REQS. 11 TONS EA.
POURED CONCRETE
CHURCH BUILDING FOR:
CHRIST EPISCOPAL CHURCH
SLIDELL, LOUISIANA

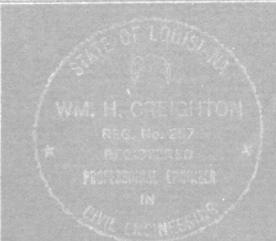

COMM. NO. 885
DATE: 22 APRIL 1968
REVISED:
SHEET NO. 6 OF 1

ERNEST AND WOLF - ARCHITECTS
910 CHARTRES ST. NEW ORLEANS, LA.