




A COVERED PORCH FOOTING
SCALE: N.T.S.

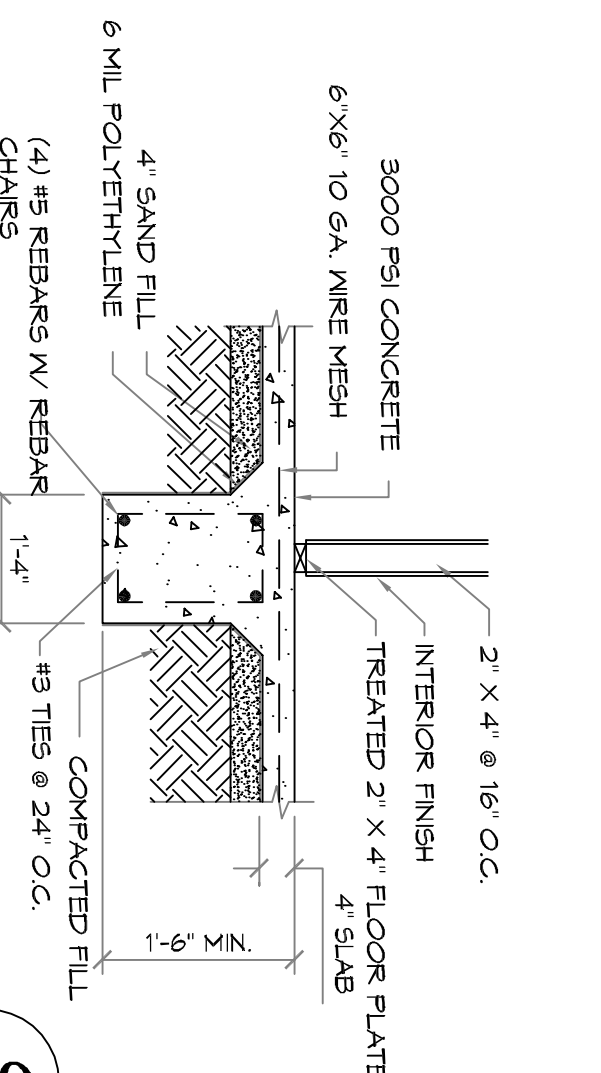


B INTERIOR GRADE BEAM
SCALE: N.T.S.

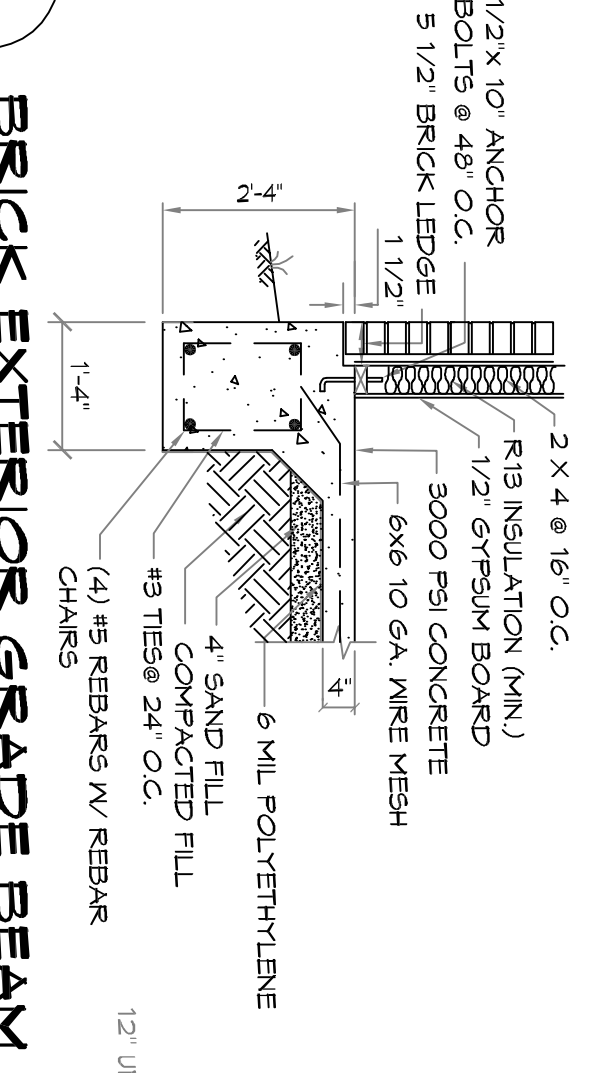


C BRICK EXTERIOR GRADE BEAM
SCALE: N.T.S.

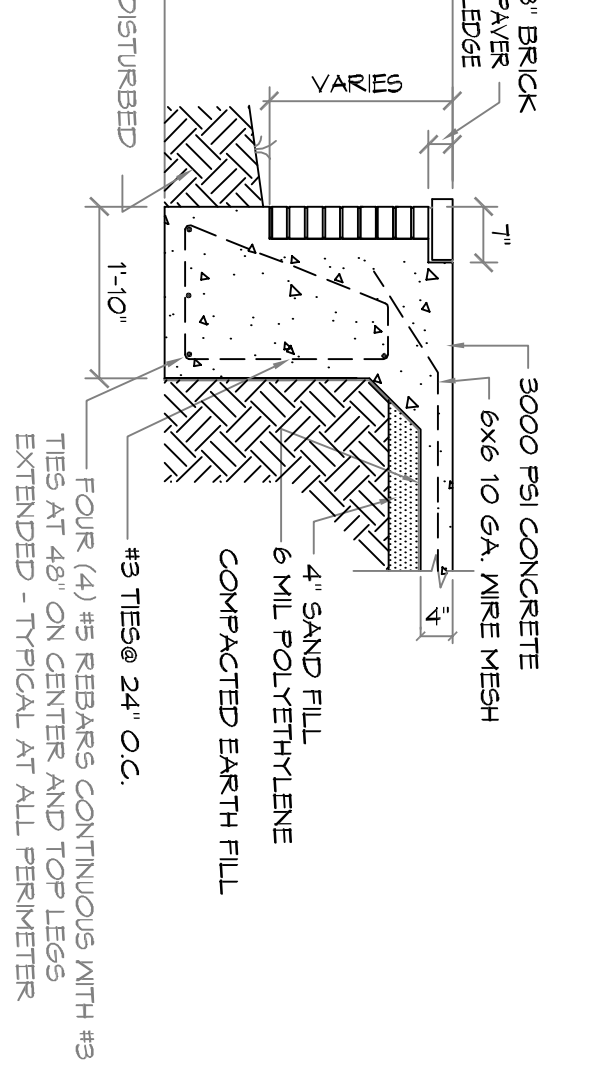

D BRICK BAND FOOTING DETAIL
SCALE: N.T.S.

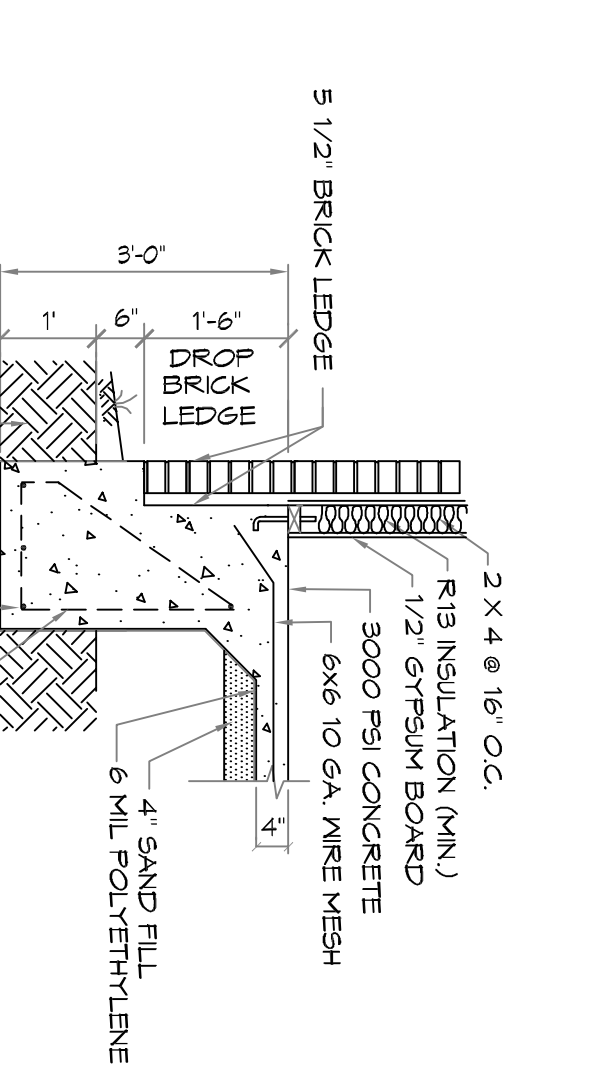

E 18\"/>

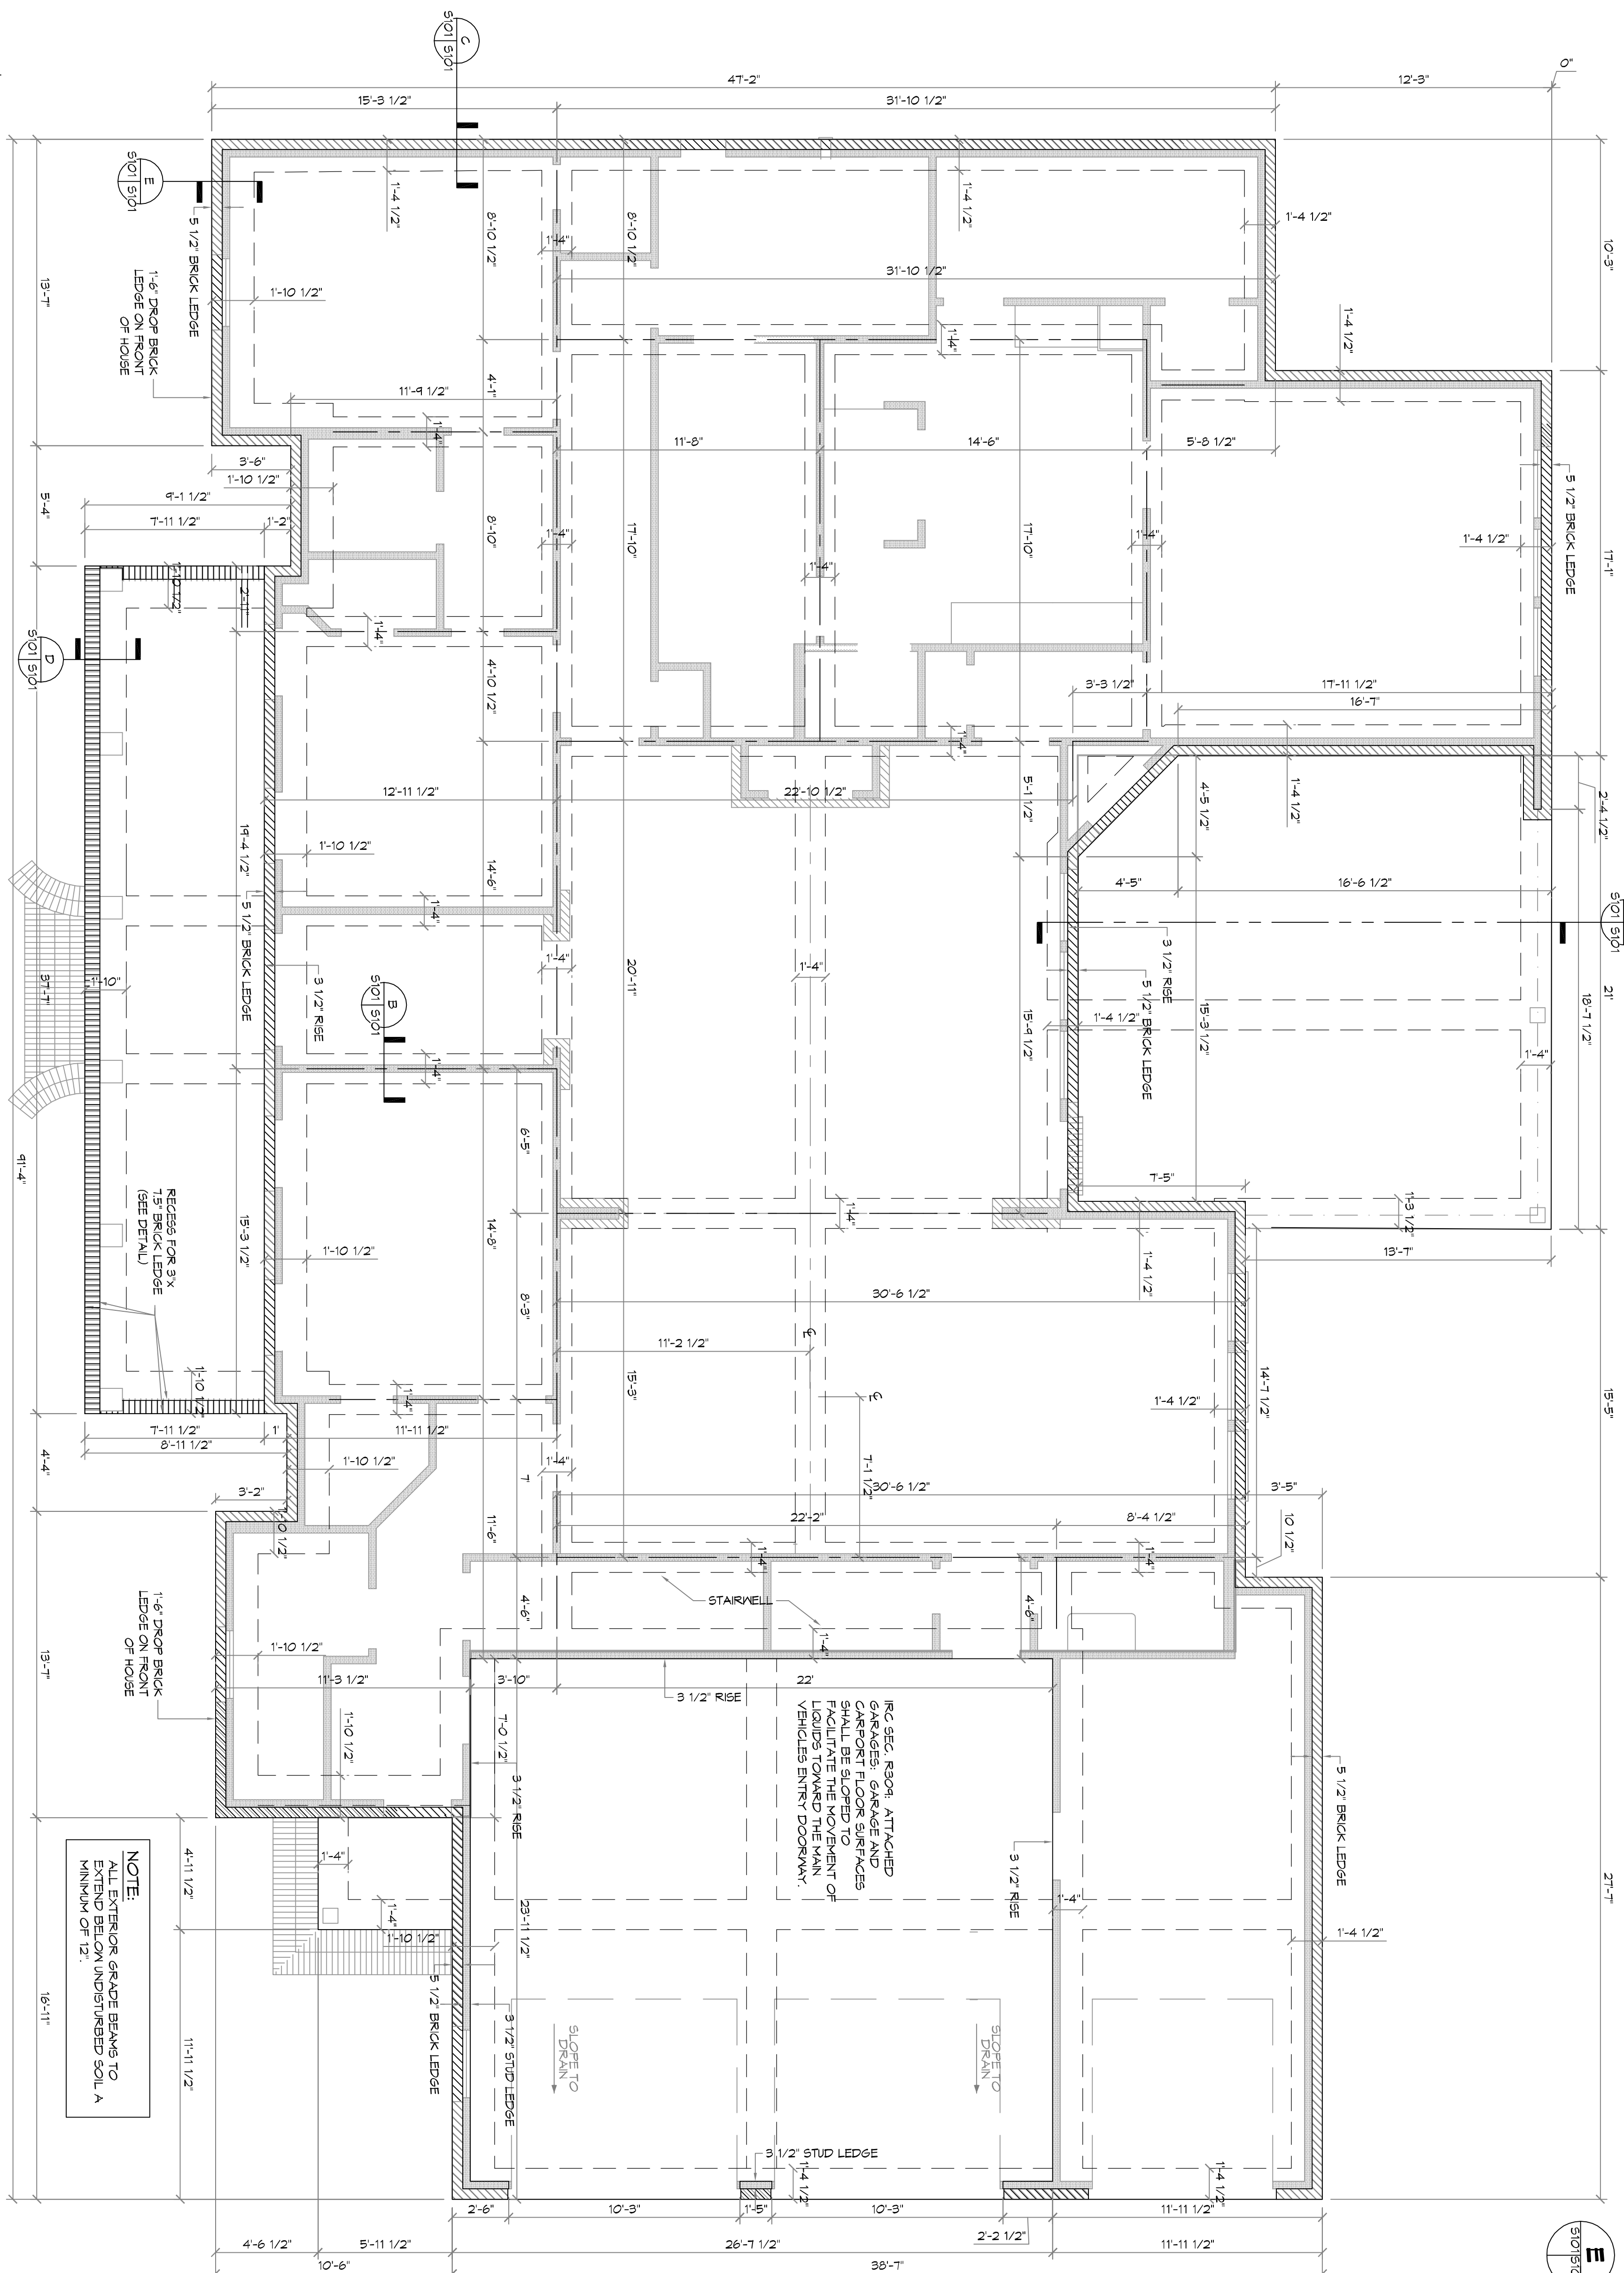

FOUNDATION PLAN
SCALE: 1/4\"/>

CONCRETE NOTES:

- REFER TO BUILDING PLANS FOR DOOR OPENINGS AND EXACT DIMENSIONS.
- USE CONCRETE BRICK SUPPORTS TO MAINTAIN REINFORCING CLEARANCES. DO NOT USE CWJ OR FACE BRICK.
- FOUNDATION DESIGN BASED ON A-4 FILL DIRT COMPACTED TO 95% DENSITY (ASTM D-1557). FILL PLACED @ 8\"/>

SITE PREPARATION NOTES:

- REMOVE TOP SOIL (0\"/>

FOUNDATION AND SITE WORK NOTES:

- CHECK ELECTRICAL PLAN FOR ANY CONDUIT OR FLOOR RECEPTACLES.
- TERMINATE REBAR TO SOLID FLOOR TO PERMITS. CONCRETE AND REBAR CERTIFICATE FOR OWNER.
- GRADE LOT TO DRAIN AWAY FROM THE FOUNDATION A MINIMUM OF 6\"/>

#	DESCRIPTION	DATE

DAMMON ENGINEERING, INC.
LOUISIANA & MISSISSIPPI

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NEW RESIDENTIAL
Z O Y A K M S I D E N Z C H

292 HIGHLAND BLUFF DR
SLIDELL, LA 70461

JOB No: 2019 DATE: 05-17-2019
DRAWN BY: JAGMM CHECKED BY: CKD

5101

FOUNDATION AND DETAILS

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