




D:\MISC_A\1 - General\A201 - Fire Station #10\Drawings\A201 - Fire Station #10 - Elevations.dwg, PLOT DATE: 11/13/2025, 10:52:00 AM, User: brian.mistich

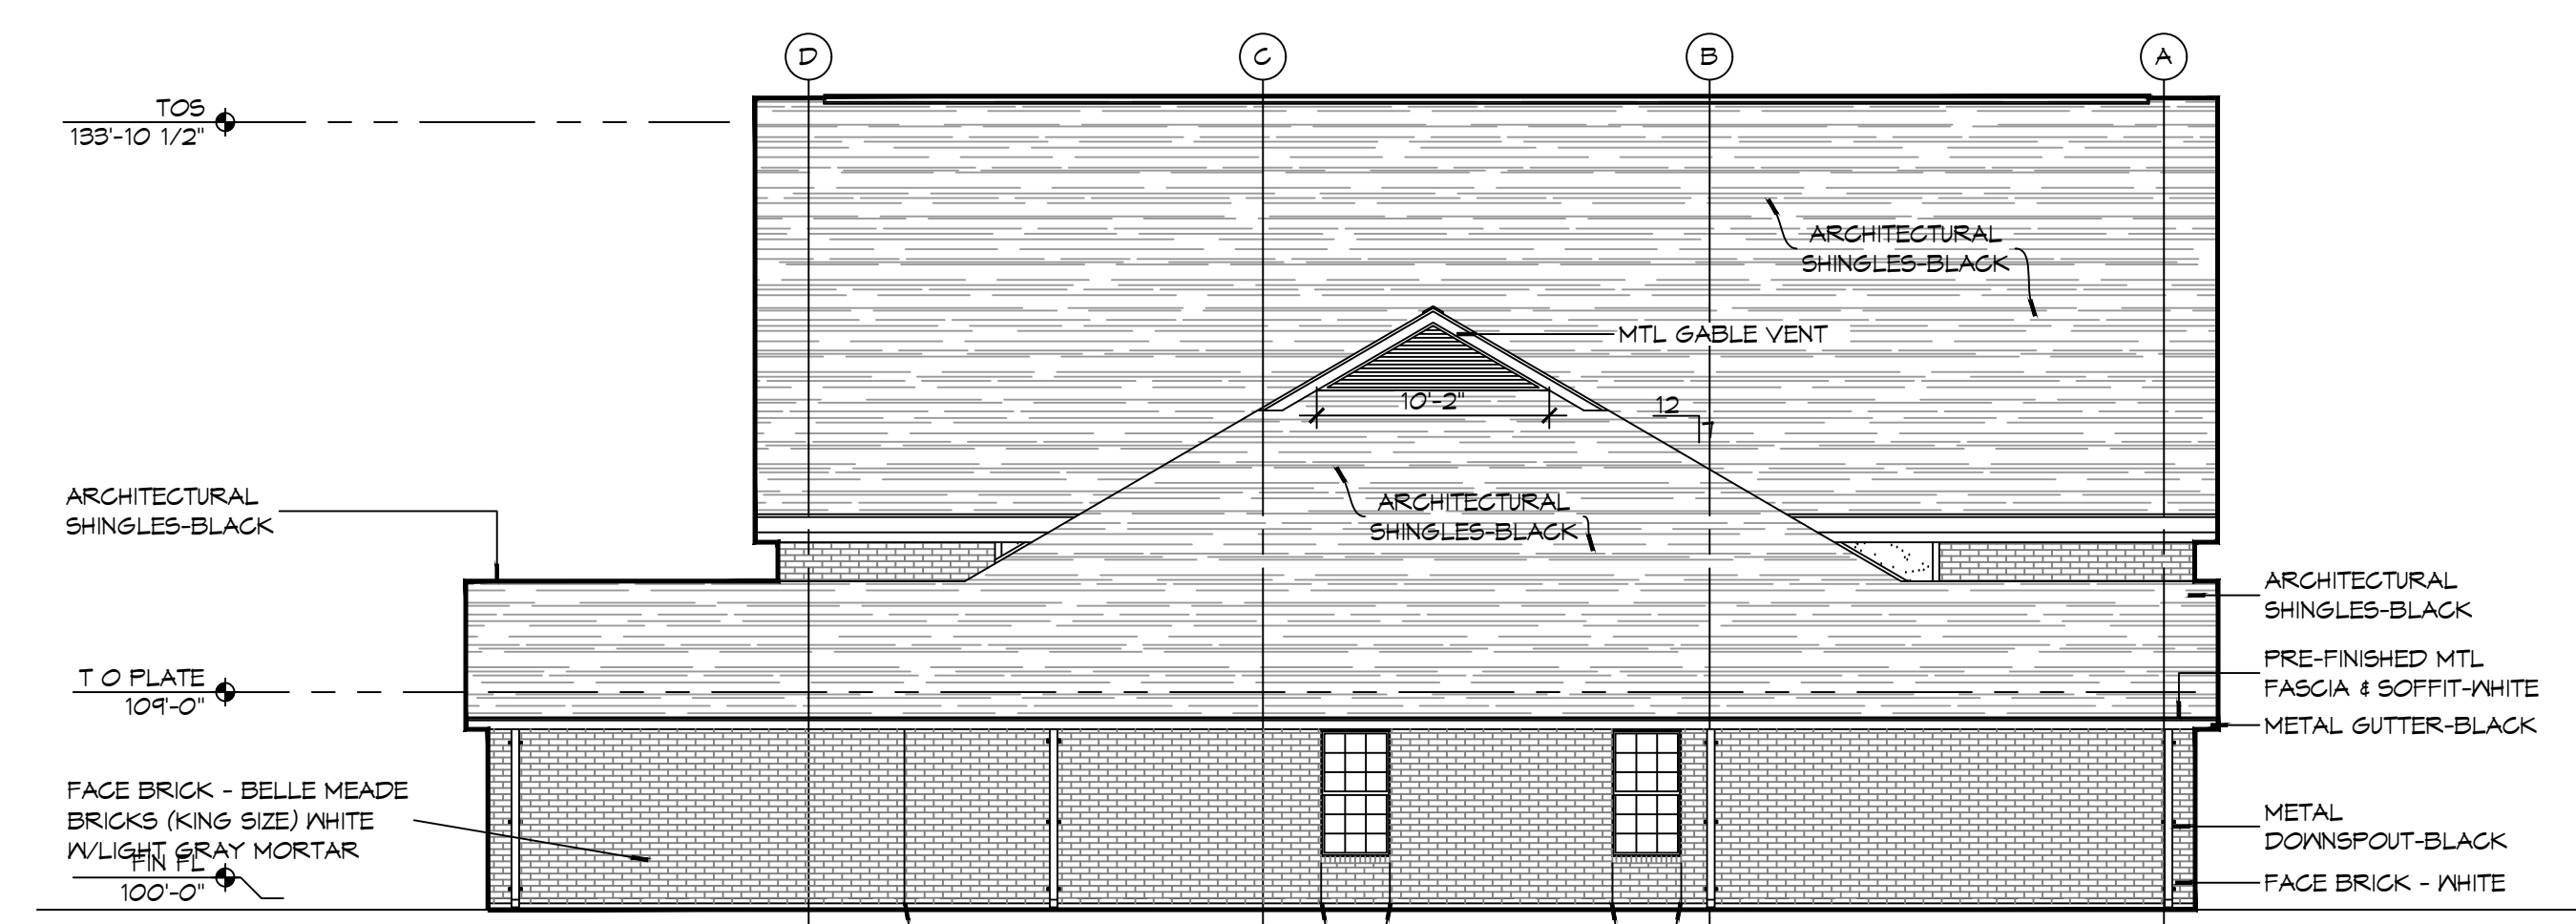


4 EXTERIOR ELEVATION LEFT SIDE
SCALE: 1/8" = 1'-0"

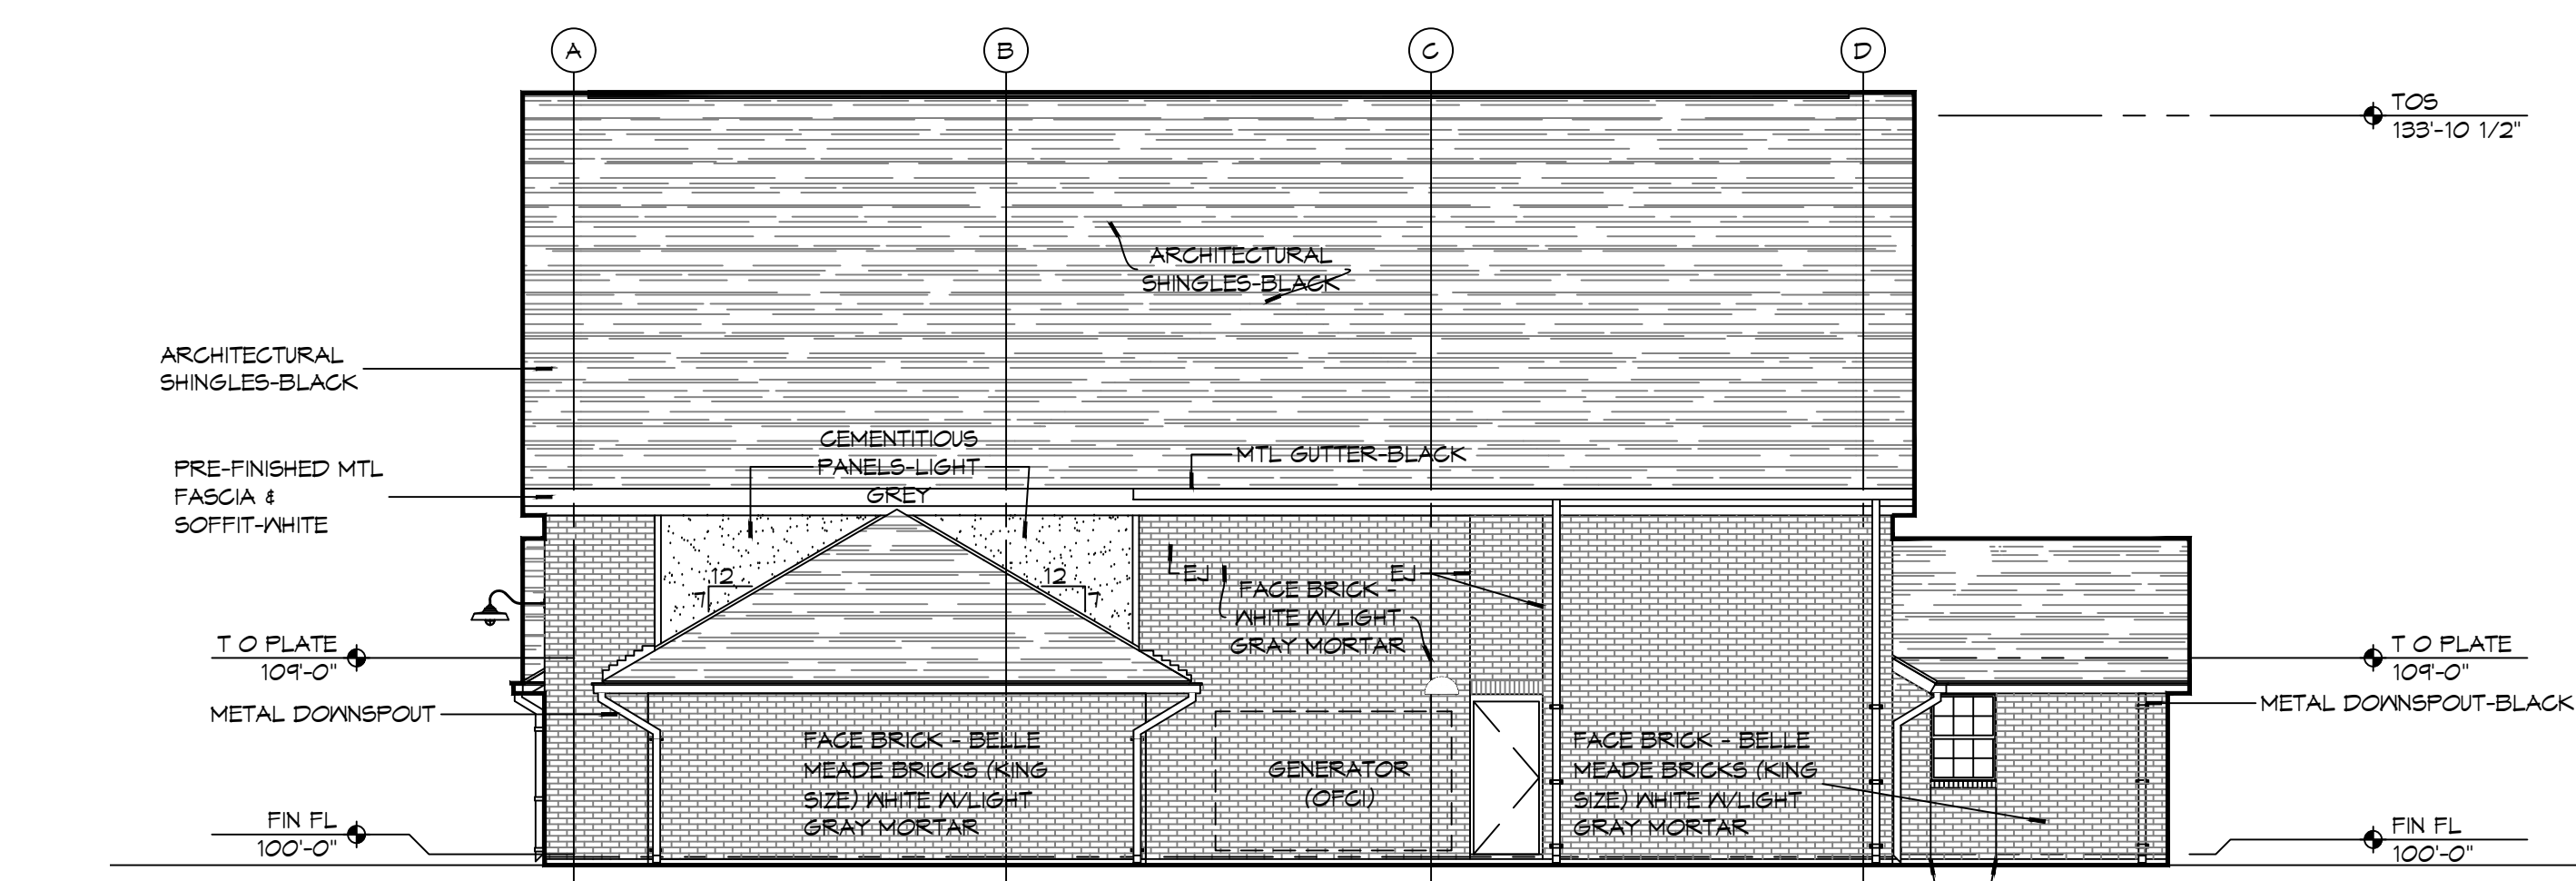

3 EXTERIOR ELEVATION RIGHT SIDE
SCALE: 1/8" = 1'-0"

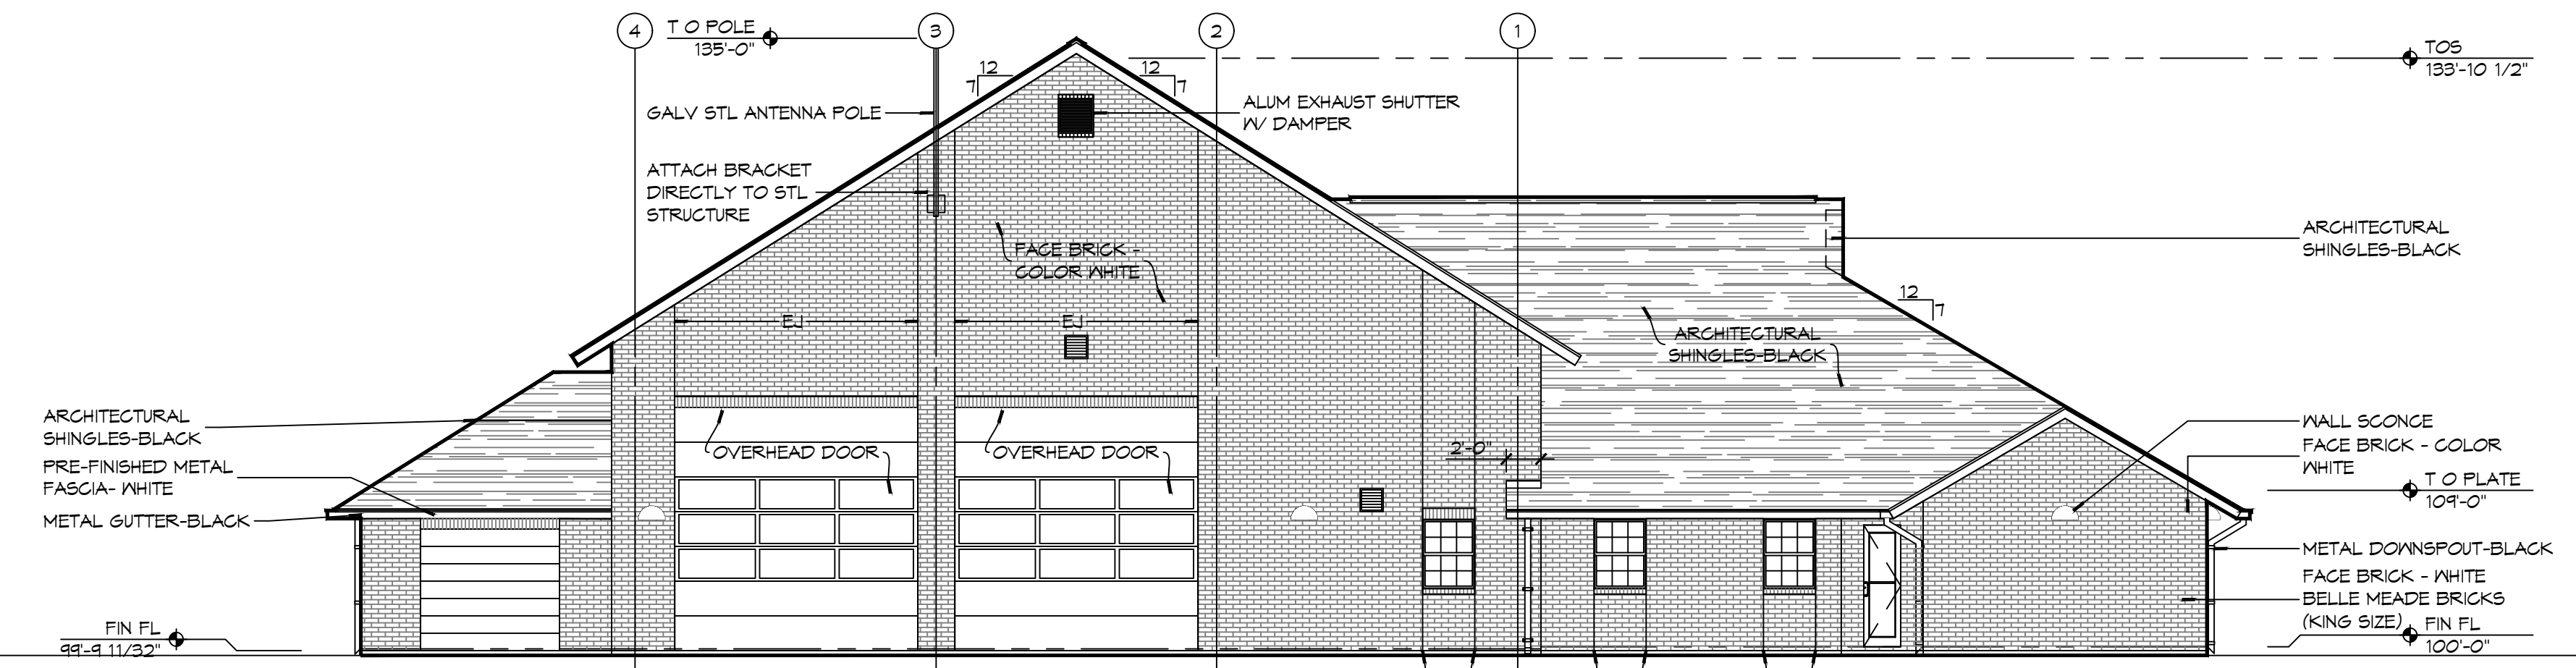


2 EXTERIOR ELEVATION REAR SIDE
SCALE: 1/8" = 1'-0"

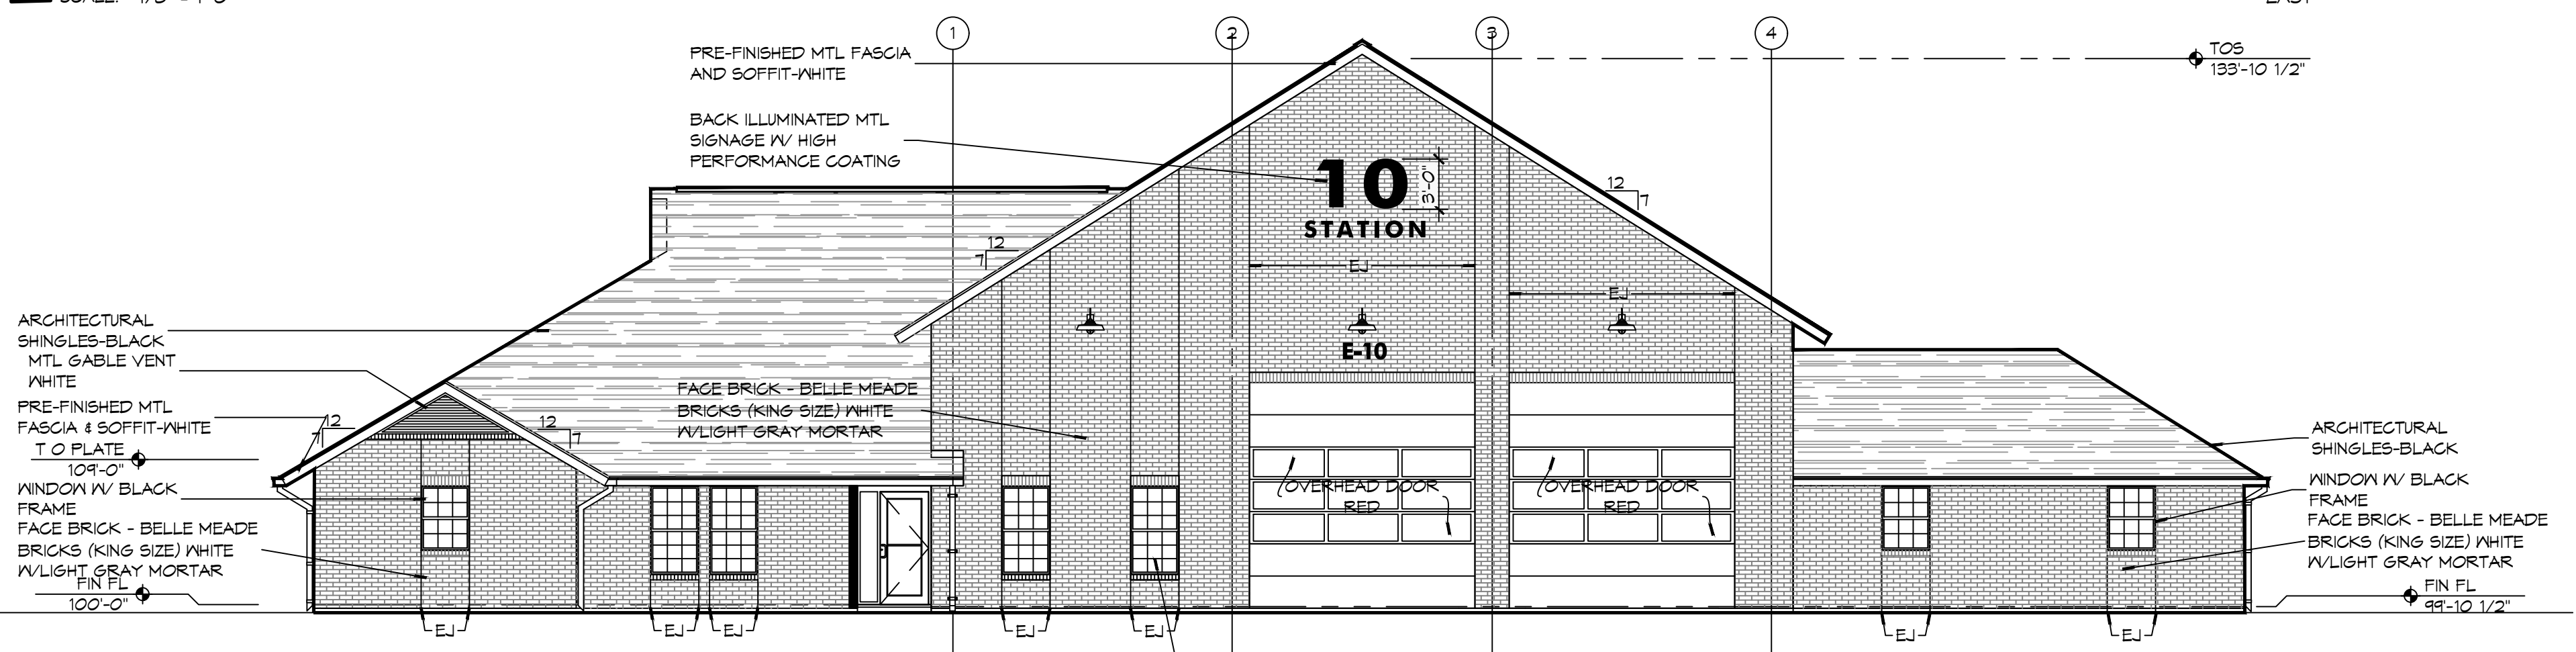


1 EXTERIOR ELEVATION FRONT SIDE
SCALE: 1/8" = 1'-0"

GENERAL ELEVATION NOTES

1. REFER TO SHEET A101 FOR WINDOW TYPE ELEVATIONS.
2. WINDOW TYPES NOT INDICATED THIS SHEET ARE IDENTIFIED ON SHEET A501.
3. CONTRACTOR SHALL REVIEW LOCATIONS AND INTENT OF ALL MASONRY EXPANSION/CONTROL JOINTS WITH ARCHITECT PRIOR TO CONSTRUCTION. REFER TO ELEVATIONS FOR INDICATED JOINT LOCATIONS. LAY PINE STRAIN DOWN TO AVOID RAINWATER SPLASHING RED CLAY ONTO BRICK.
4. SEE S/A501 FOR TYPICAL MASONRY EXPANSION JOINT DETAILS.
5. MASONRY DIMENSIONS ARE NOMINAL.
6. ALL FLASHING SHALL BE DONE IN STRICT ACCORDANCE WITH THE FLASHING MANUFACTURER'S PUBLISHED SPECIFICATIONS AND DETAILS. THIS TO INCLUDE AMOUNT OF OVERLAP AND INSTALLATION OF DRIP EDGES, IF REQUIRED.
7. LINE OF FINISH GRADE ON EXTERIOR ELEVATIONS IS APPROXIMATE AND ARE INTENDED FOR REFERENCE PURPOSES ONLY. REFER TO CIVIL GRADING PLAN FOR FINISH GRADE ELEVATIONS.
8. SEE SHEET A101 FOR EXPANSION JOINTS (EJ) IN HIDDEN LOCATIONS AND NOT SHOWN ON THIS SHEET.

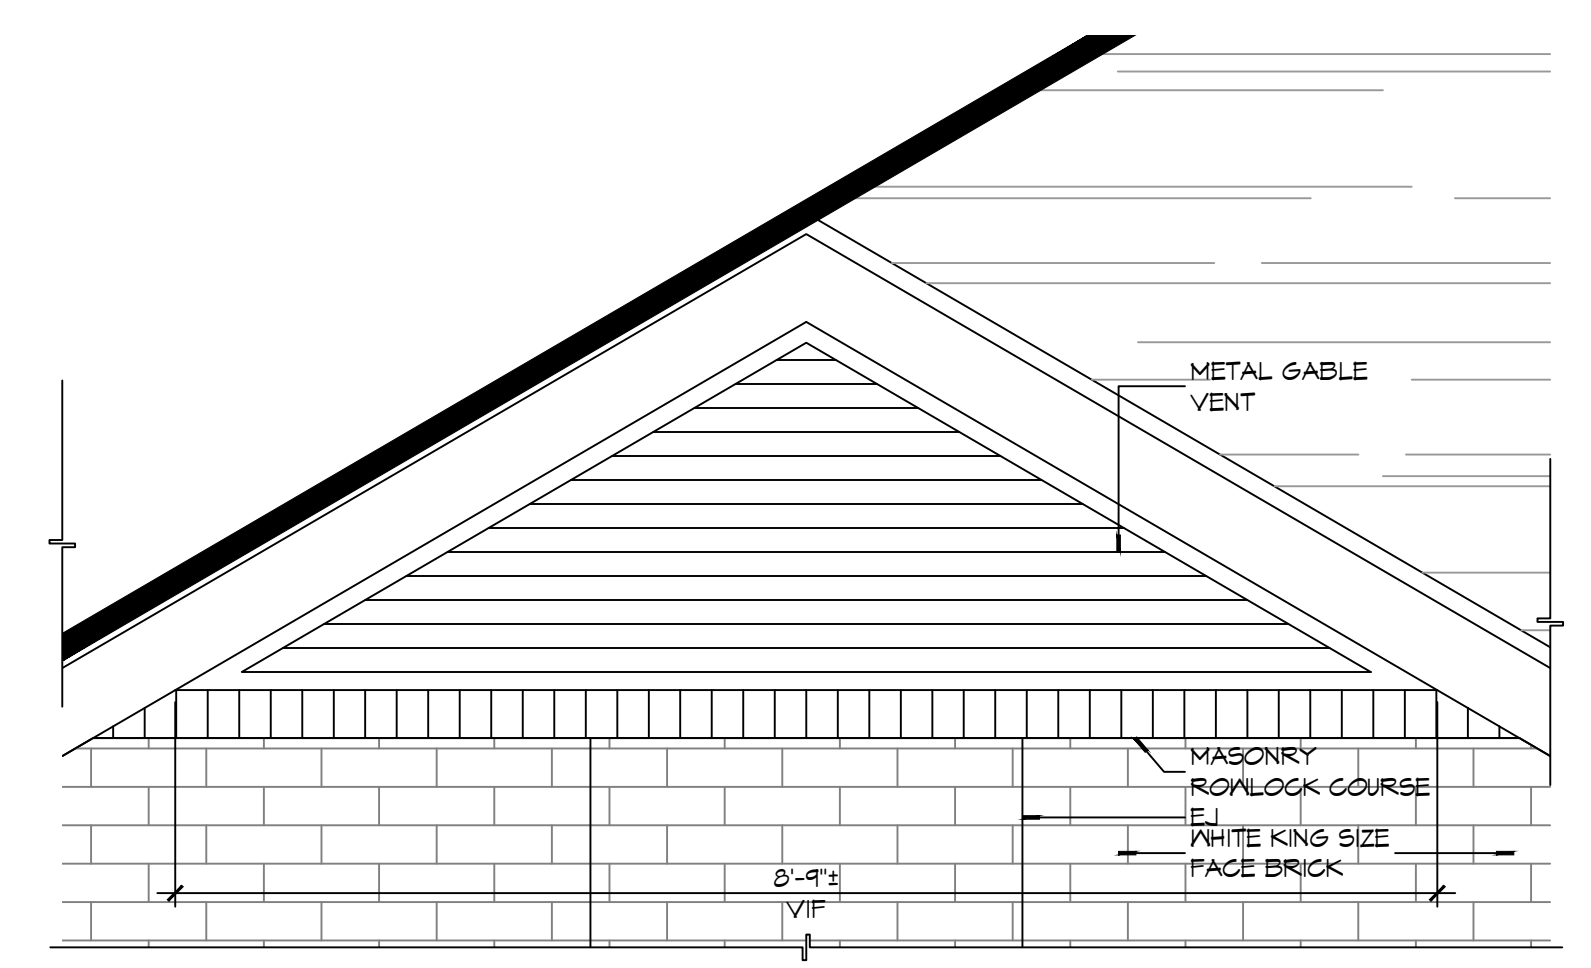

6 DETAIL ELEVATION
SCALE: 3/4" = 1'-0"

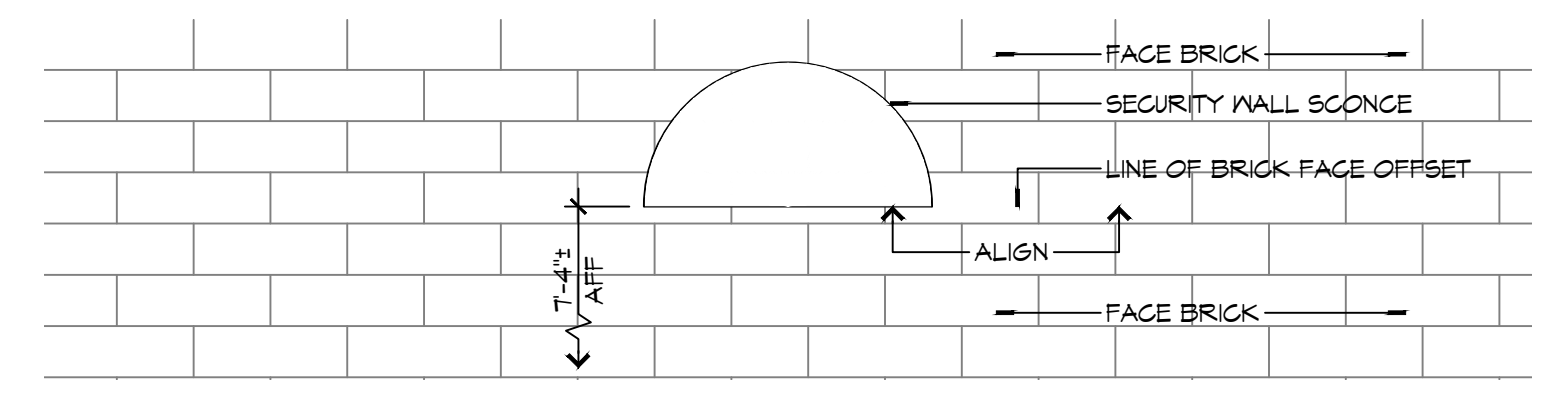

5 DETAIL ELEVATION
SCALE: 1" = 1'-0"

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 PH: 985.649.5832

| # | DESCRIPTION | DATE |
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NEW FIRE STATION #10
 ST. TAMMANY FIRE PROTECTION DISTRICT NO. 1
 248 LAKESHORE VISTA BLVD
 SLIDELL, LA 70461
 JOB No: 2519 DATE: 12-05-2025
 DRAWN BY: CKD CHECKED BY: JMS

SHEET TITLE:
 BUILDING ELEVATIONS

DRAWING NUMBER:

A201