




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 PLOT DATE: 12/05/2015 10:30:32 AM  
 PLOT BY: BMM

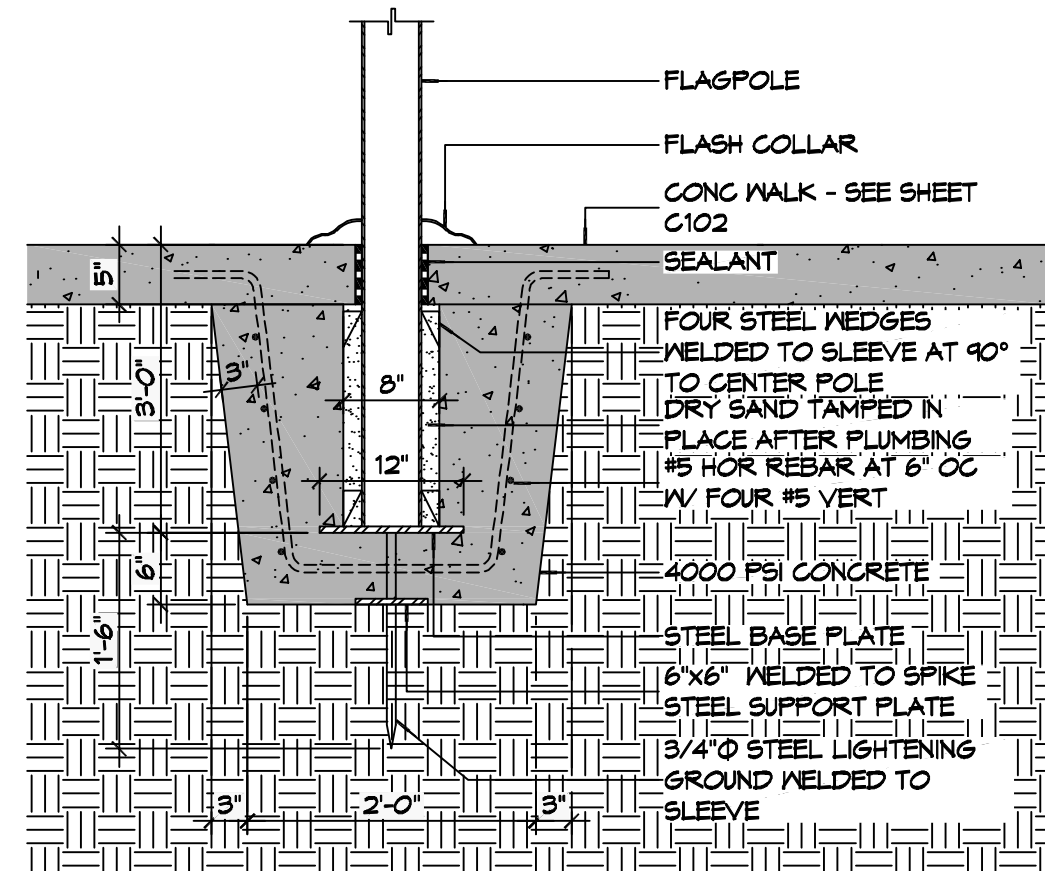

**6 DETAIL**  
SCALE: 3/4" = 1'-0"  
FLAGPOLE FOUNDATION

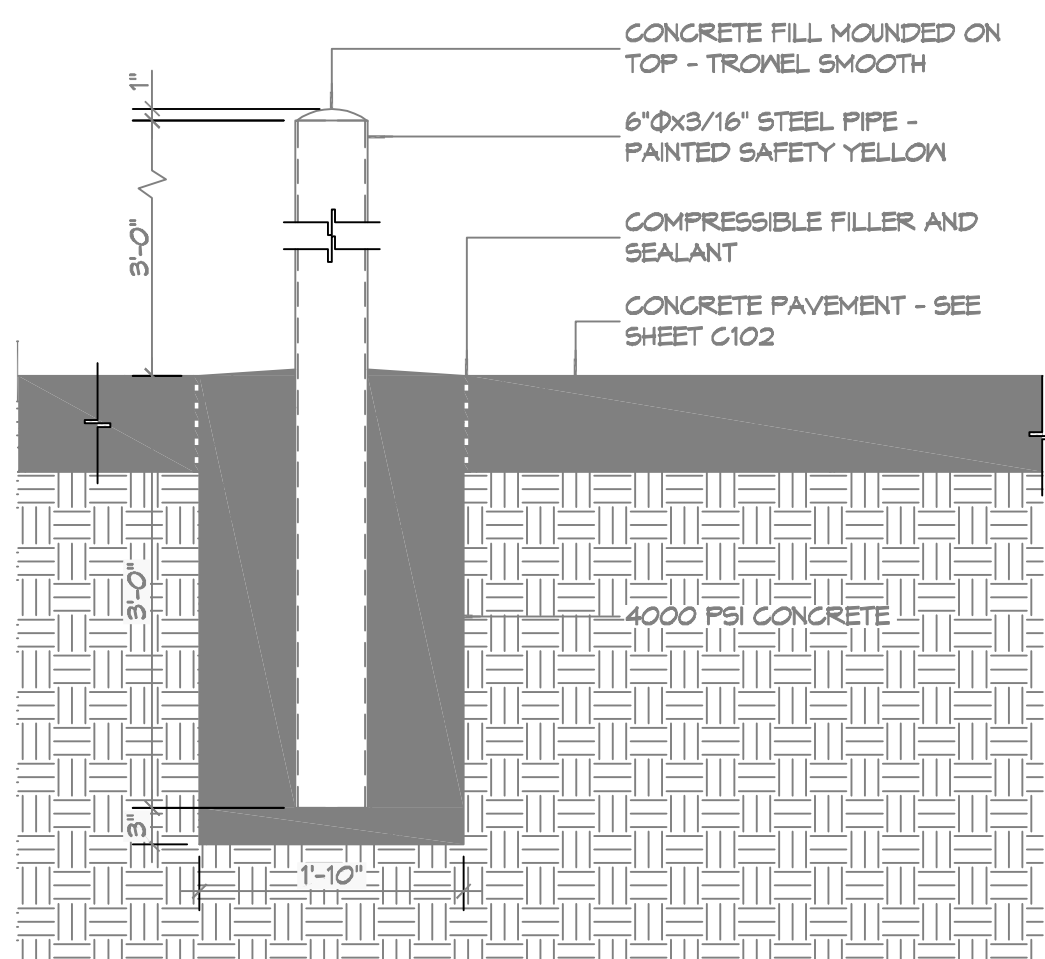

**4 DETAIL**  
SCALE: 3/4" = 1'-0"  
TYPICAL BOLLARD

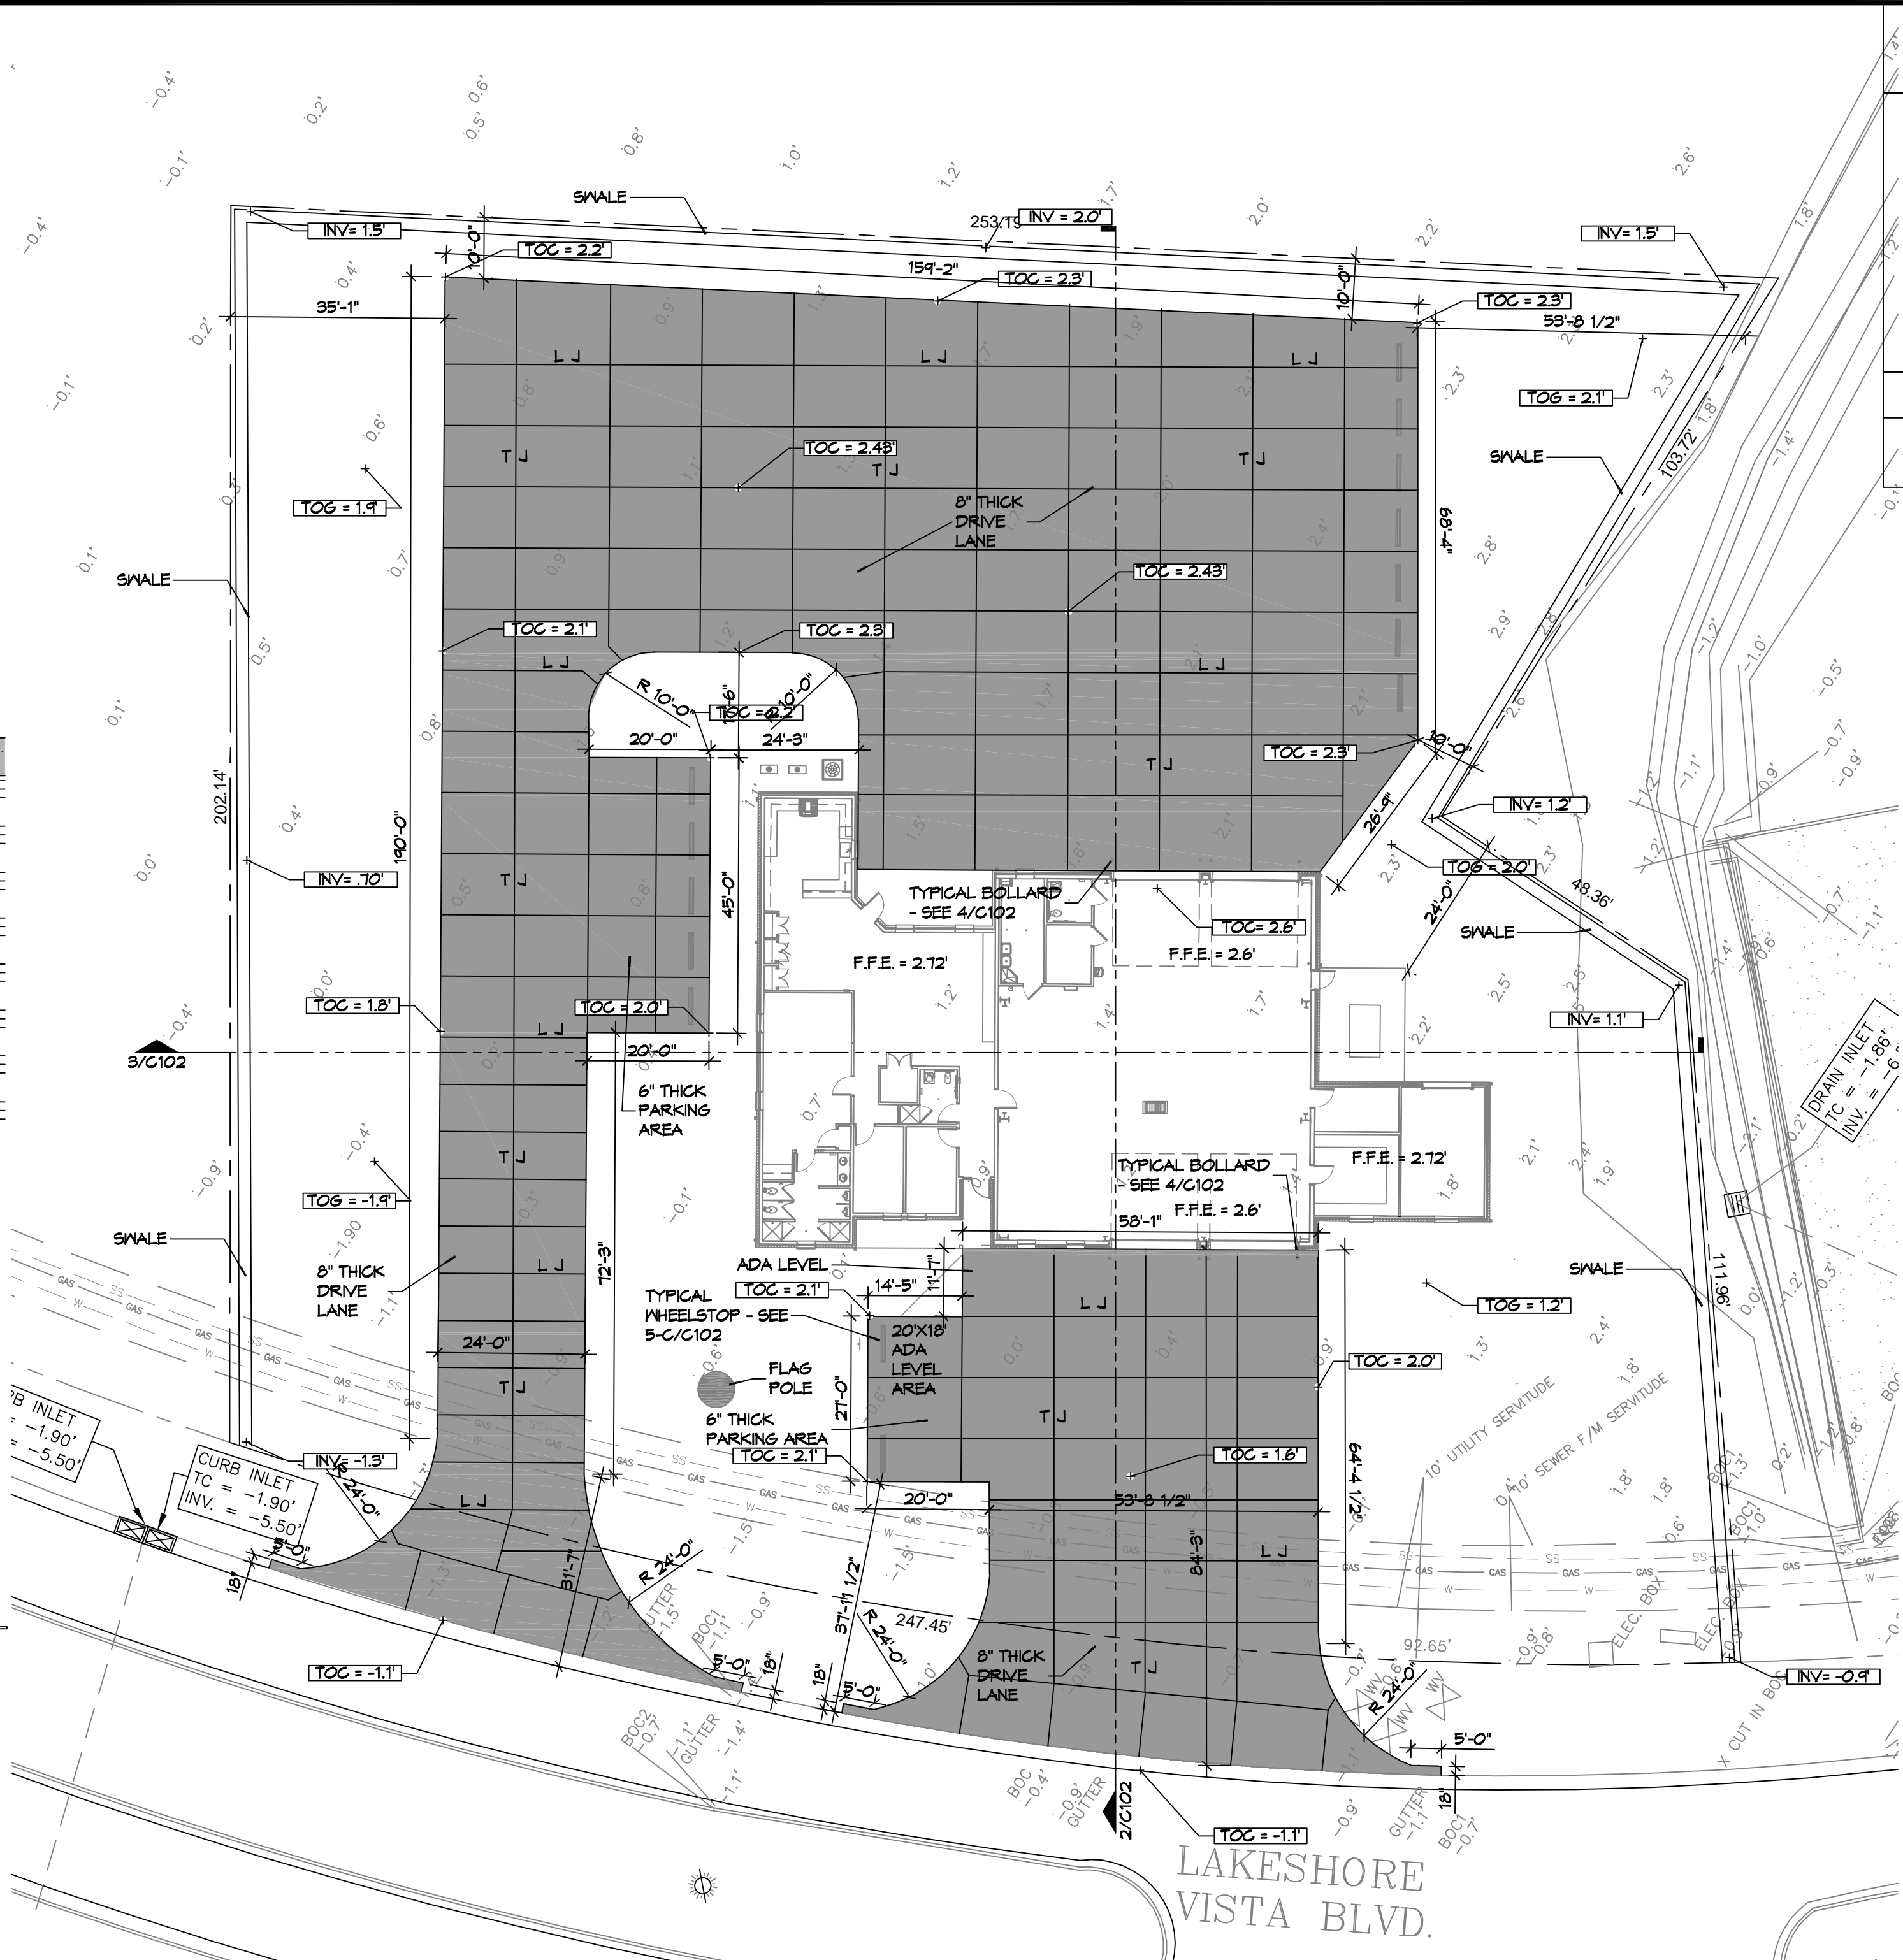

**1 PAVING PLAN**  
SCALE: 1" = 20'-0"

**SITE DRAINAGE LEGEND**


- PROPERTY LINE
- TOC=11.47' TOP OF CONCRETE
- TOG=11.47' TOP OF GRADE
- INV=11.47' INVERT OF PIPE
- 00.00 EXISTING ELEVATIONS

**AREA OF FILL (CUBIC YARDS)**

2,840 CUBIC YARDS


**GENERAL NOTES**

1. ALL NEW CONCRETE SHALL HAVE A MINIMUM COMPRESSIVE STRENGTH OF 4,000 PSI AT 28 DAYS AND A MINIMUM THICKNESS OF 6". CONCRETE MIX SHALL BE IN ACCORDANCE WITH THE LATEST REVISION OF ASTM C-150 TYPE 1.
2. CONCRETE PAVING THICKNESS SHALL VARY AS FOLLOWS:
  - a. APRONS & LOADING AREAS = 8" THICKNESS
  - b. DRIVE LANES & PARKING AREAS = 6" THICKNESS
3. ALL REINFORCING STEEL SHALL MEET ASTM-A615 (GRADE 60).
4. ALL REINFORCING STEEL SHALL BE SECURELY SUPPORTED TO PREVENT BOTH VERTICAL AND HORIZONTAL MOVEMENT DURING CONCRETE PLACEMENT. ALL CONTROL AND EXPANSION JOINTS SHALL BE LOCATED AND INSTALLED AS SHOWN ON THE PAVING PLAN AND IN ACCORDANCE WITH THE MANUFACTURER'S RECOMMENDATIONS.
5. ALL SUB GRADE FILL SHALL BE SELECT GRANULAR MATERIAL COMPACTED TO 95% STANDARD PROCTOR DENSITY IN A MAXIMUM OF 6" LIFTS.
6. CONTRACTOR SHALL CONTACT THEIR REGULATORY DEPARTMENT OF ENGINEERING PRIOR TO CONDUCTING ANY WORK.
7. ANY WORK WITHIN THE ROADWAY OR ADJACENT TO THE ROADWAY CAUSING AN INTERFERENCE TO VEHICULAR TRAFFIC MUST CONFORM TO THE REQUIREMENTS SET FORTH BY THE UNIFORM MANUAL OF TRAFFIC CONTROL DEVICES OF THE STATE OF LOUISIANA. THE CONTRACTOR MUST FURNISH ALL NECESSARY TRAFFIC SIGNS AND/OR BARRICADES AND MAINTAIN THEM DURING CONSTRUCTION ACTIVITY.

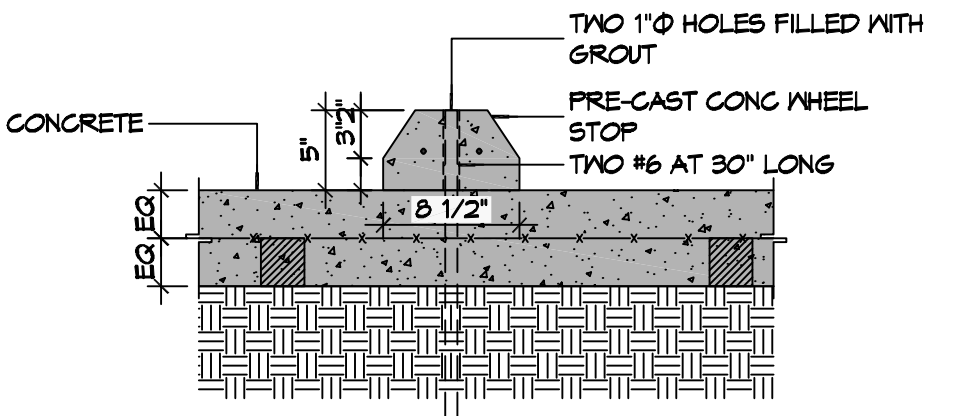


**C TYPICAL WHEEL STOP**

**6\"/>**

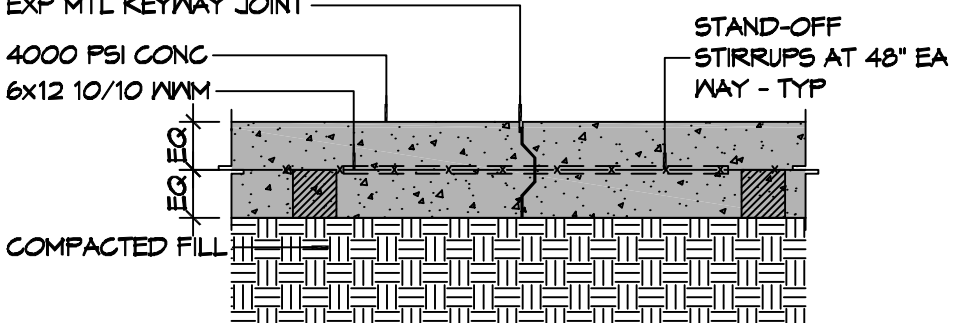


**B TYPICAL PAVEMENT JOINT**

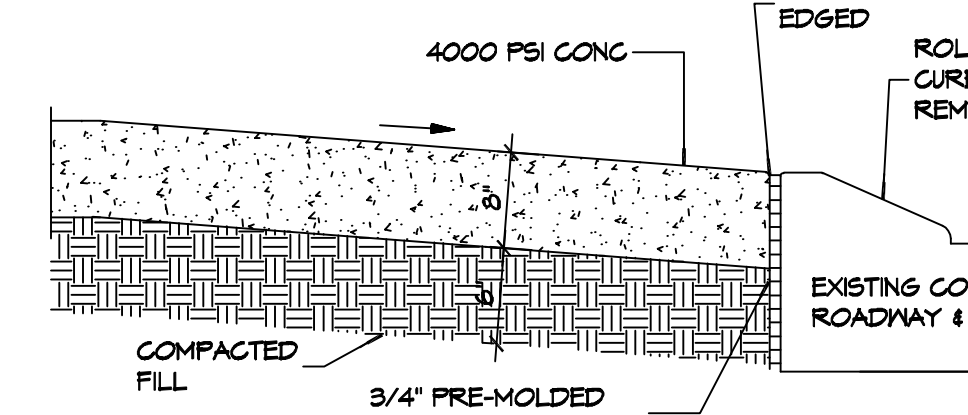


**NOTE:**  
APRON SHALL BE MINIMUM 8" THICK CONCRETE OVER 6" COMPACTED SAND BASE. CONCRETE SHALL BE 4000 PSI.

**A EXISTING PAVING TO NEW PAVING**

**5 PAVING DETAIL**  
SCALE: N.T.S.

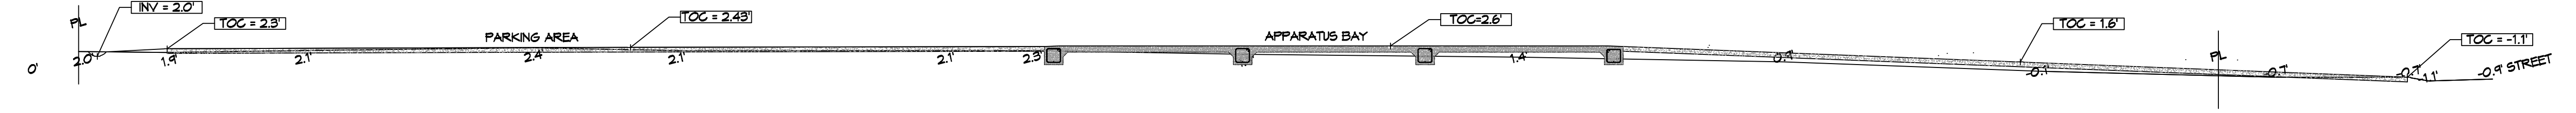

**2 SITE PROFILE**  
SCALE: 1" = 10'

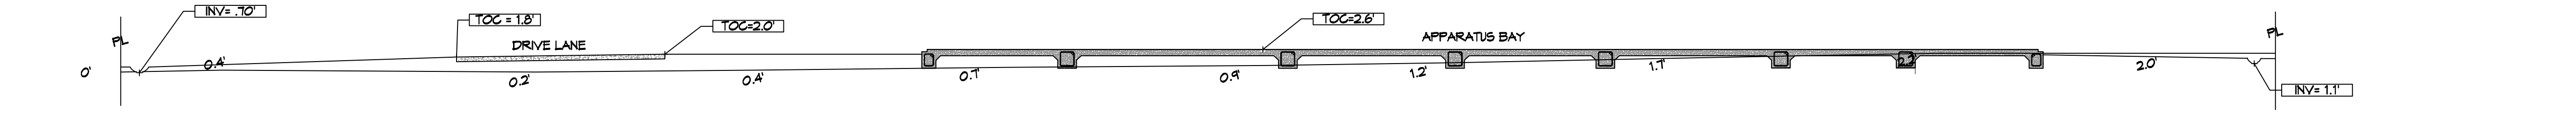

**3 SITE PROFILE**  
SCALE: 1" = 20'

**DAMMON ENGINEERING, INC.**  
 LOUISIANA & MISSISSIPPI  
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 554 Old Spanish Trail  
 Slidell, LA 70458  
 www.dammonengineering.com  
 info@dammonengineering.com  
 PH: 985.649.5832

#	DESCRIPTION	DATE



**NEW FIRE STATION #10**  
**ST. TAMMANY FIRE PROTECTION DISTRICT NO. 1**  
 246 LAKESHORE VISTA BLVD  
 SLIDELL, LA 70461  
 JOB No: 2519  
 DATE: 12-05-2015  
 DRAWN BY: BMM  
 CHECKED BY: CKD

SHEET TITLE:  
 DETAIL SITE GRADING AND PAVING PLAN, PAVING DETAILS

DRAWING NUMBER:

**C102**