




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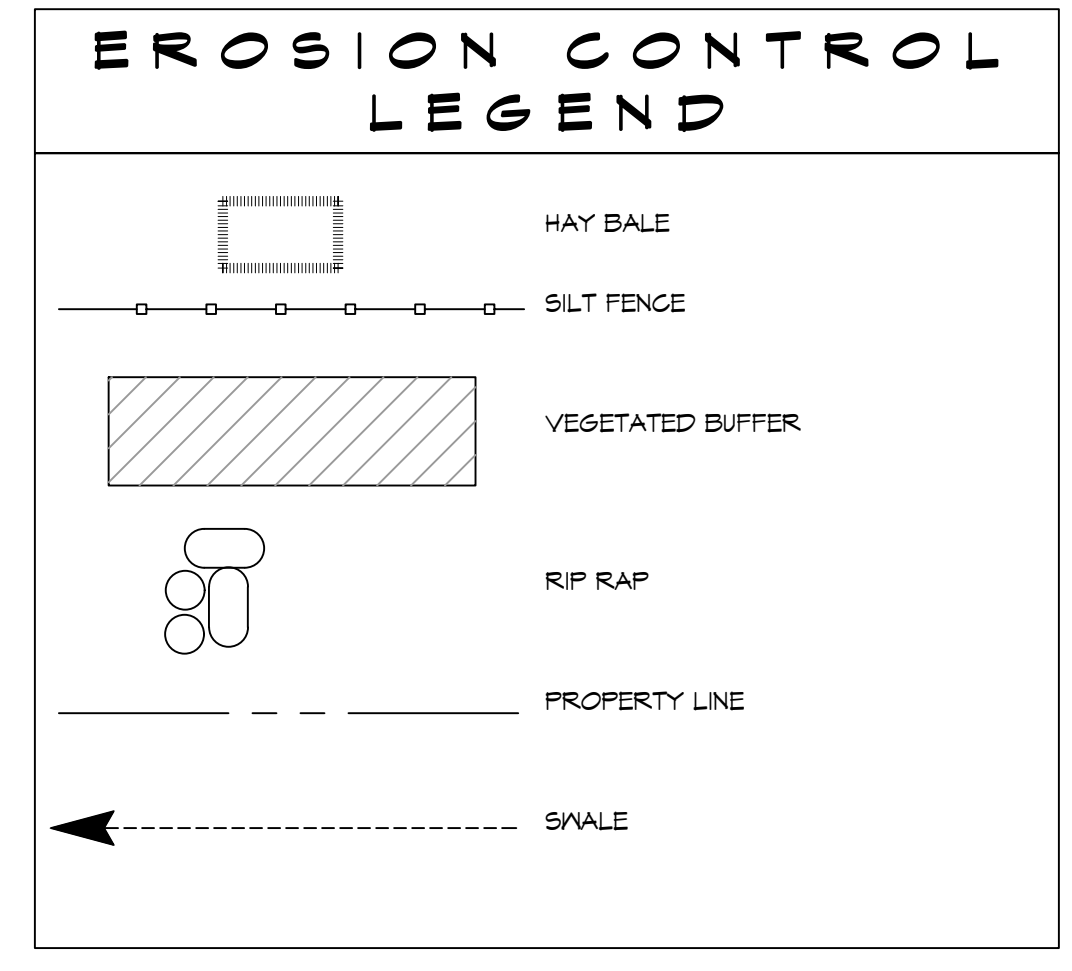
1 PROPOSED SITE PLAN
SCALE: 1" = 10'-0"

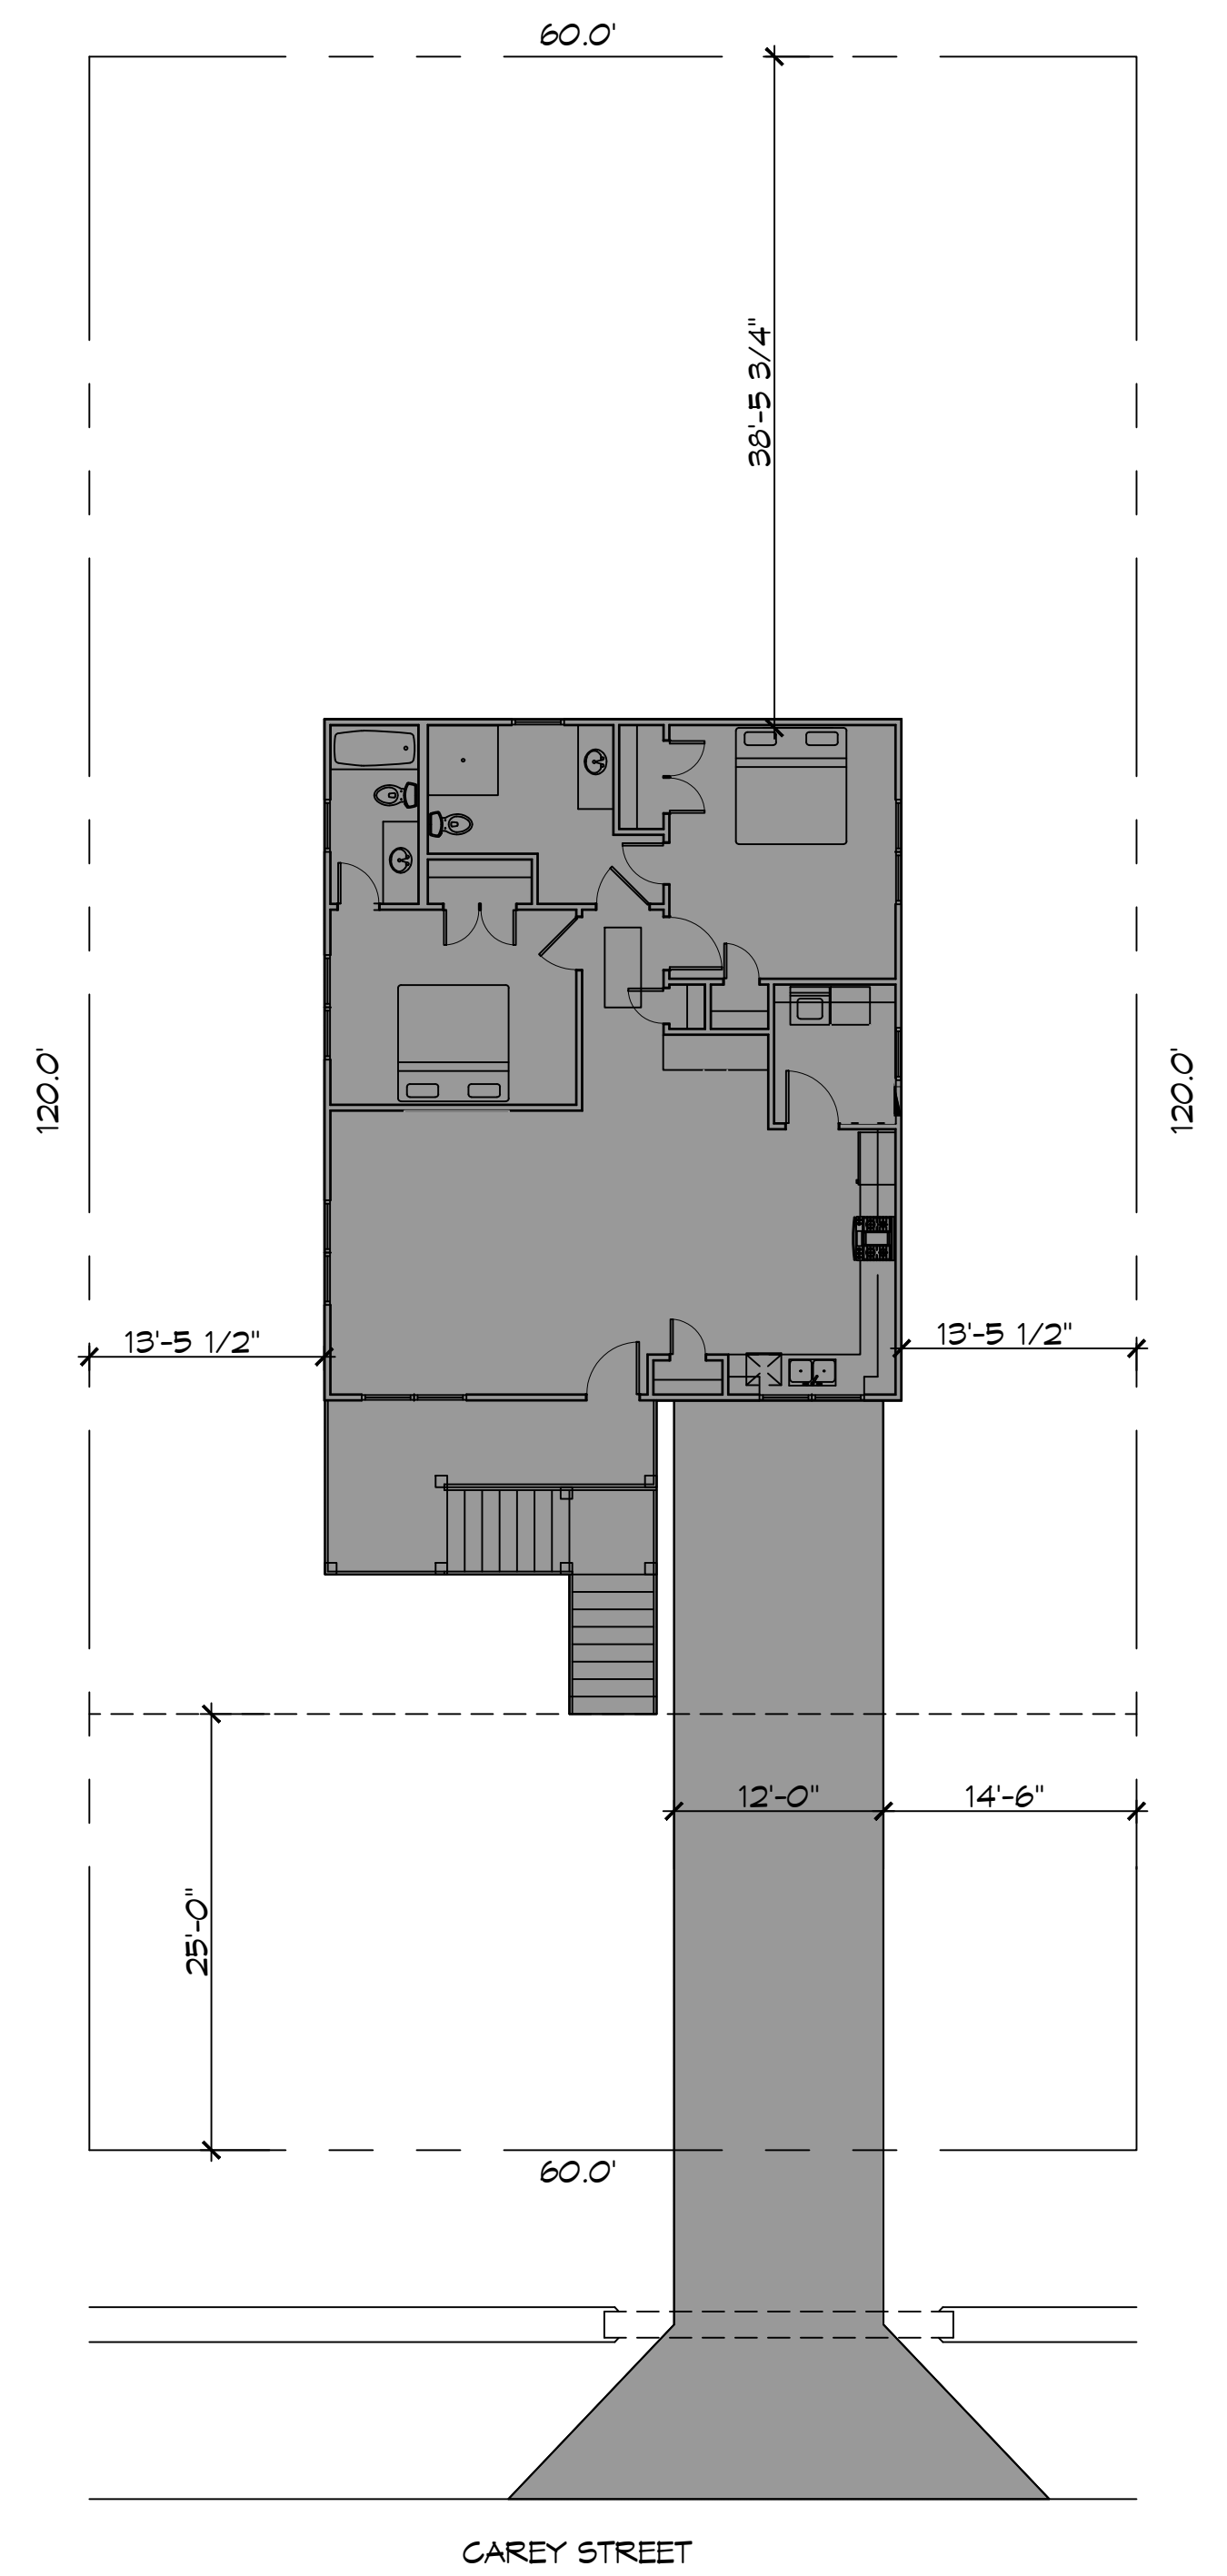

2 PROPOSED DRAINAGE PLAN
SCALE: 1" = 10'-0"

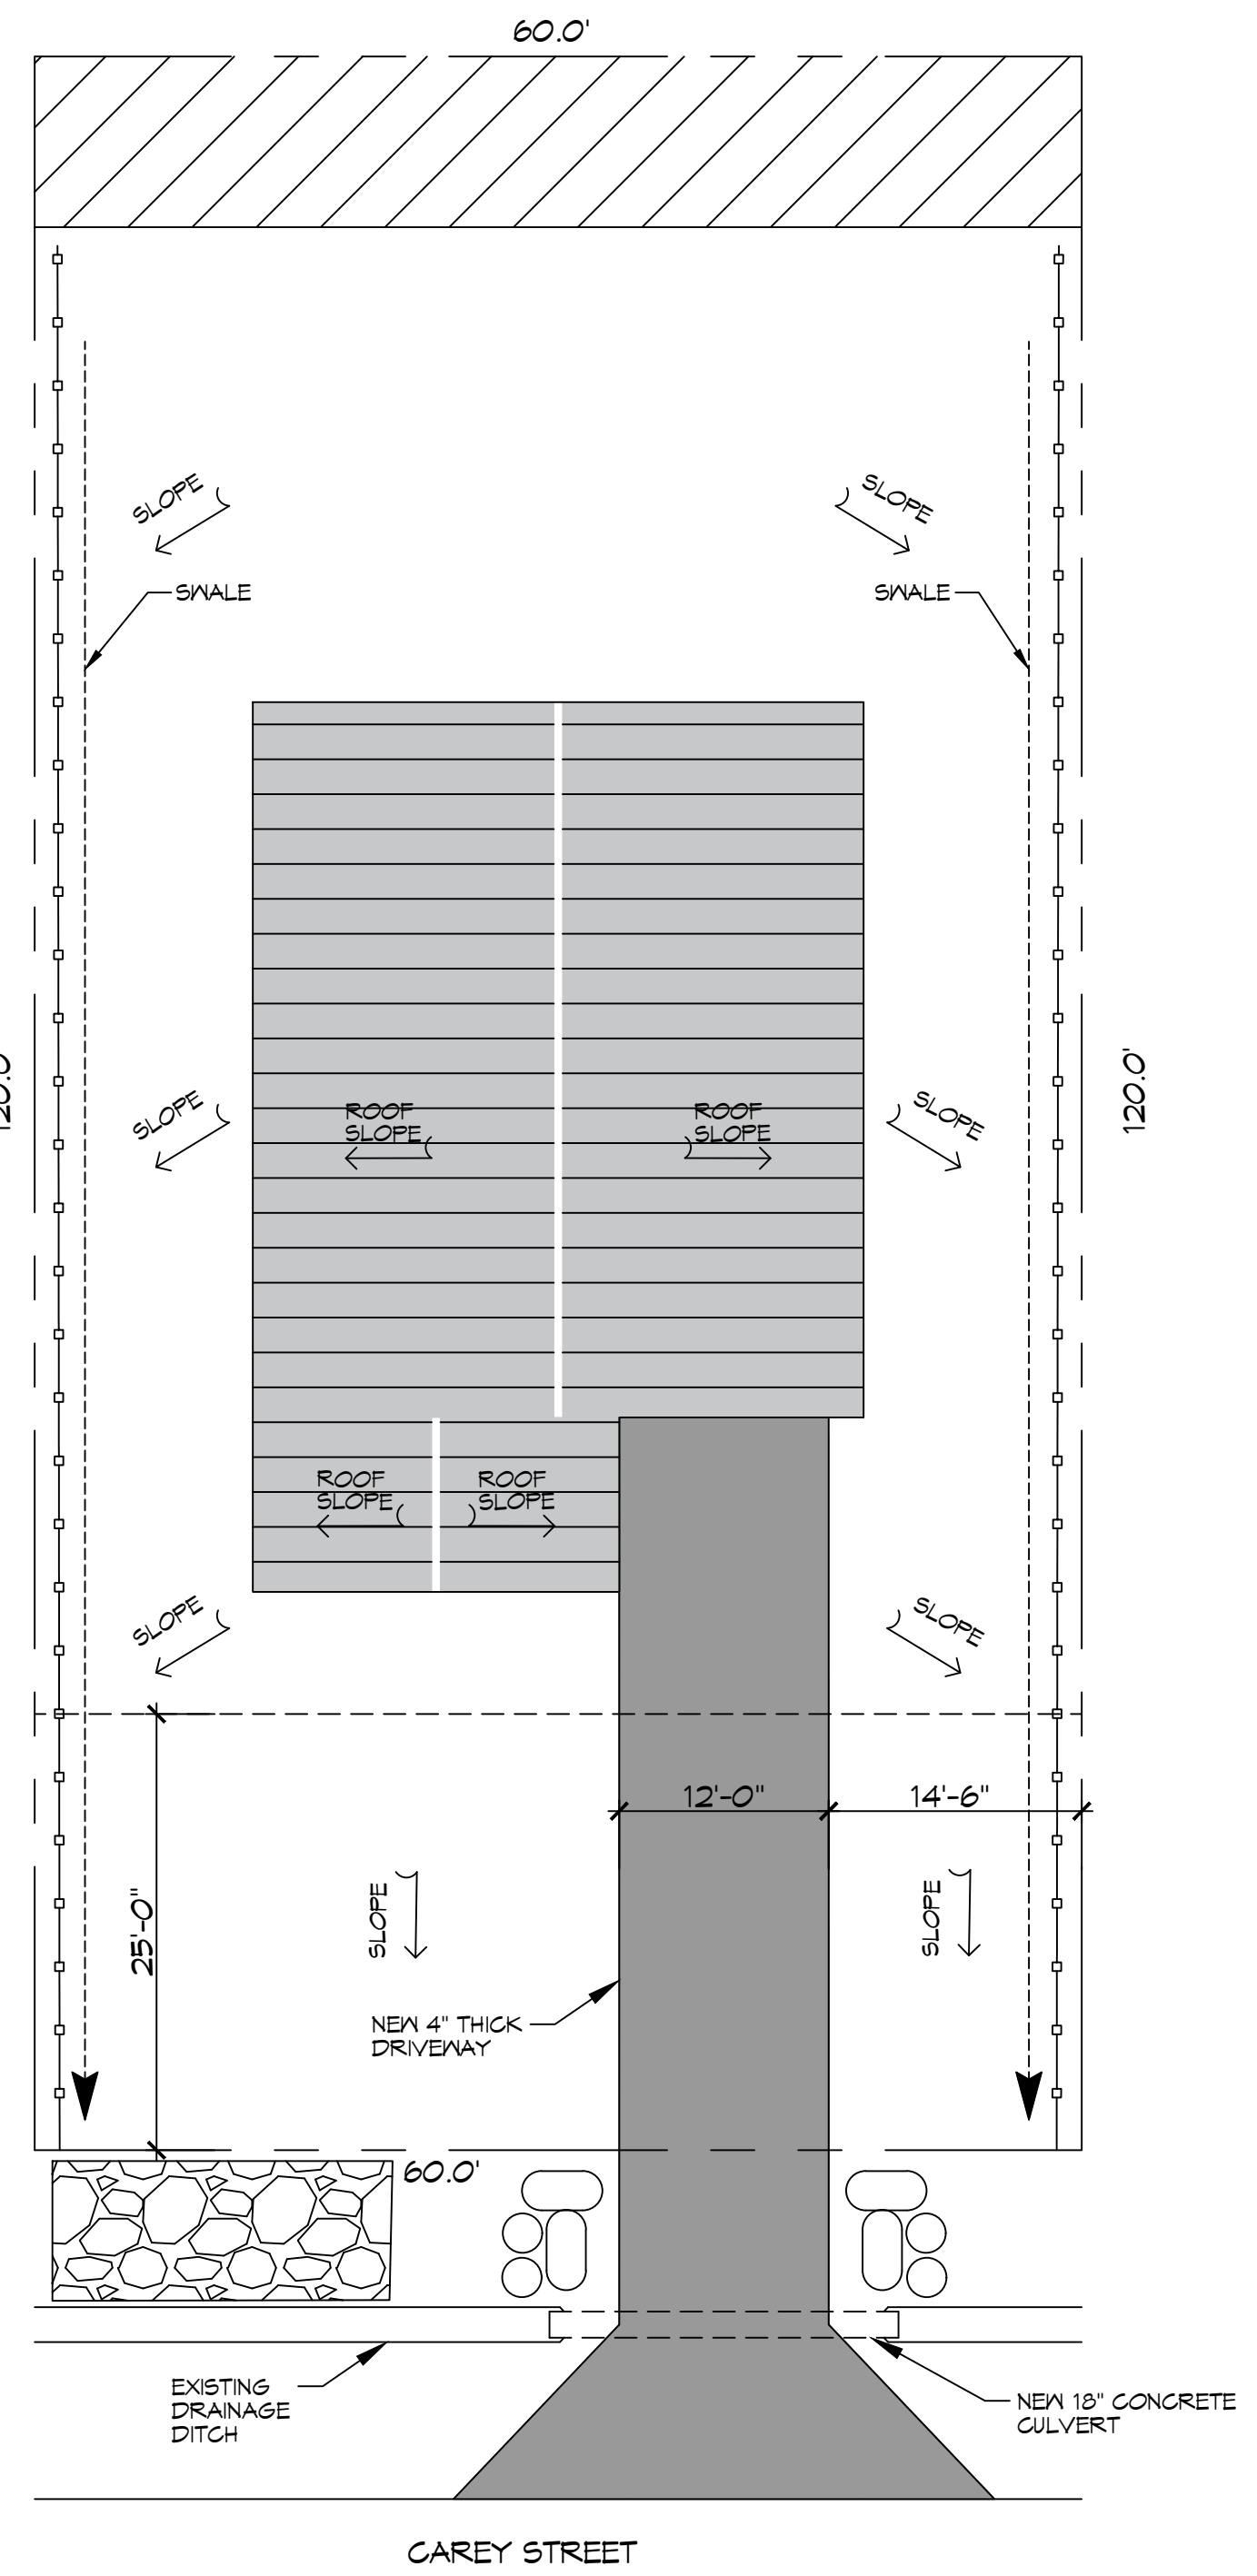

SWALE
SCALE: N.T.S.

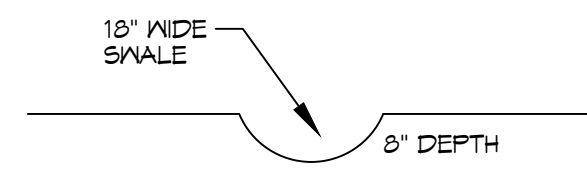

ZONING	
RESIDENTIAL DISTRICT	
FLOOD ZONE	
FLOOD ZONE: AE B.F.E.=9.0' F.F.E.=15.3'	
SQUARE FOOTAGE	
LIVING = 1,287 SQ. FT. FRONT PORCH = 190 SQ. FT. TOTAL SQ. FT. = 1,477 TOTAL SQ. FT.	
DESIGN CRITERIA	
THE CONSTRUCTION FOR SAID RESIDENCE, WHERE WIND SPEED IS 140 MILES PER HOUR AND V&S WIND SPEED IS 130 MPH, WIND EXPOSURE ZONE C, IS DESIGNED IN ACCORDANCE WITH: AMERICAN FOREST AND PAPER ASSOCIATION (AF&PA) WOOD FRAME CONSTRUCTION MANUAL FOR ONE AND TWO FAMILY DWELLINGS (WFCM) 2001 EDITION AS WELL AS THE INTERNATIONAL RESIDENTIAL CODE (IRC) 2021 EDITION. STRUCTURE SHALL BE BUILT TO THE 2021 INTERNATIONAL ENERGY CONSERVATION CODE (2021 IECC) AND STATE AMENDMENTS ADOPTED JULY 1, 2023.	
DRAINAGE NOTES	
<ol style="list-style-type: none"> CONTRACTOR SHALL PROVIDE ALL LABOR, MATERIAL, TRANSPORTATION, SUPERVISION, CLEAN-UP, SERVICES, AND EQUIPMENT FOR A COMPLETE OPERATING SYSTEM. PROVIDE POSITIVE DRAINAGE AWAY FROM BLDGS AND SHALL SLOPE TOWARDS EXISTING DITCHES AND CULVERTS. 	
GENERAL SITE NOTES	
<ol style="list-style-type: none"> PROVIDE ALL LABOR, MATERIAL AND EQUIPMENT FOR A COMPLETE OPERATING SYSTEM. CONTRACTOR IS TO FIELD VERIFY ALL EXISTING UTILITY LOCATIONS, ELEVATIONS, AND INVERTS PRIOR TO COMMENCING ANY WORK. CONTRACTOR SHALL PAY NECESSARY FEES FOR THE UTILITIES CONNECTIONS. CONTRACTOR TO BE RESPONSIBLE TO VERIFY ANY INVERTS AND SET NEW INVERTS OF SEWAGE AND DRAINAGE PIPES. ALL WORK AND MATERIAL TO COMPLY STRICTLY TO THE LATEST LOCAL CITY PARISH, STATE, AND NATIONAL GOVERNING CODES. SEWAGE LINES 3" AND SMALLER SHALL BE SLOPED 1/4" PER FOOT AND LINES THAT ARE 4" AND LARGER SHALL BE SLOPED 1/8" PER FOOT. CONTRACTOR SHALL CONTACT LOUISIANA ONE CALL PRIOR TO COMMENCEMENT OF SITE EXCAVATION. 	

SHEET INDEX	
SHEET #	SHEET TITLE
C101	PROPOSED SITE PLAN
C102	DRAINAGE PLAN
S101	HOUSE PILING PLAN & FLOOR FRAMING PLAN
S102	CEILING JOIST PLAN AND HOLD DOWN LOCATIONS/ SHEAR WALL
S103	ROOF FRAMING PLAN
S104	FRAMING SECTION PLAN
S105	CONNECTION DETAILS, SCHEDULES, & NOTES
A101	FLOOR PLAN
A102	ELEVATION PLAN
P101	PLUMBING PLAN
M101	MECHANICAL PLAN
E101	ELECTRICAL PLAN

DAMMON ENGINEERING, INC.
LOUISIANA & MISSISSIPPI
www.dammonengineering.com
info@dammonengineering.com
PH: 985.649.5832

Chief Engineer: Brian Mitchell, PE
554 Old Spanish Trail
Slidell, LA 70458

REVISIONS	DATE
# <td>DESCRIPTION </td>	DESCRIPTION

NEW HOUSE PLAN

BOBBY HARRISON

3030 CAREY DRIVE
SLIDELL, LOUISIANA
70458

JOB No: **02-24-2026**
DATE: **02-24-2026**
DRAWN BY: **LJP** CHECKED BY: **BAM**

SHEET TITLE:
PROPOSED SITE PLAN

DRAWING NUMBER:

C101

SHEET No: 1 of 12