

# xfinity

**COMCAST  
104 LOIS RD.  
HOUMA, LA 70363**

**DRAWING NO.  
030024 -REV 1**

<b>xfinity BRAND APPROVAL</b>	
_____	_____
<small>XFINITY BRAND APPROVAL</small>	<small>DATE</small>

**REVISIONS**

<b>DATE:</b>	<b>REVISION # &amp; DESCRIPTION</b>
1/31/20	1. ADD MOUNTING PLATE DETAILS

**DESIGNER**  
GMB



800.861.8006  
ADVANCESIGNGROUP.COM





EXISTING ELEVATION

SCALE: 1/8" = 1'-0"



STOREFRONT ELEVATION - PROPOSED (1.0 ABOVE/1.1 BELOW)

SCALE: 3/16" = 1'-0"

**DAMMON**  
ENGINEERING, INC.  
LOUISIANA & MISSISSIPPI  
800.448.8474 www.dammonengineering.com  
PO BOX 100000 HOUMA, LA 70363

This sign is designed to withstand 141 MPH wind load

**xfinity**  
104 LOIS RD., HOUMA, LA 70363


DRAWING NO.  
**029714**  
SIGN NO.  
**FRONT ELEV 1.0**

DATE OF LAST CHANGE:  
**09/23/18**  
REVISION NO.  
**1**

**APPROVALS**  
THIS DRAWING SUPERCEDES ALL OTHER DOCUMENTS PROVIDED CONCERNING THE FABRICATION AND INSTALLATION OF THIS DESIGN. A SIGNATURE ANYWHERE ON THE DRAWING WILL BE TAKEN AS APPROVAL OF THE DESIGN AND SPECIFICATIONS AS NOTED.  
CLIENT APPROVED SIGNATURE: \_\_\_\_\_ DATE: \_\_\_\_\_  
**DESIGN DOCUMENTATION:** THIS DESIGN IS THE PROPERTY OF ADVANCE SIGN GROUP. NEITHER THE DRAWINGS NOR THE DESIGN MAY BE USED OR DISTRIBUTED WITHOUT APPROVAL OF ADVANCE SIGN GROUP.

**CONSULTANT:**  
ANDY WASSERSTROM  
**PROJECT MANAGER:**  
C. WINSTEAD  
**DESIGNER:**  
GMB  
**FILE LOC:**  
C:\CLIENT\PROJECTS\  
XFINITY\029714\REPORTS\  
029714\11 Production

**ASG** 800.861.8006  
ADVANCE SIGN GROUP ADVANCESIGNGROUP.COM  
c us

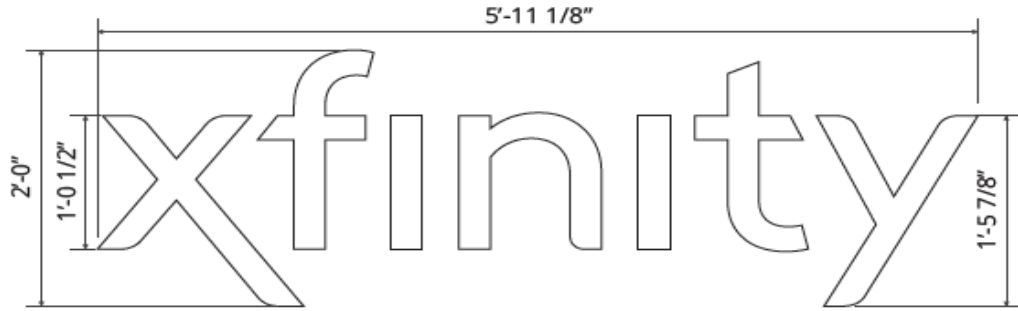

**ALUMINUM FCO LETTERS**

(1) ONE REQUIRED FOR FRONT ELEVATION


SCALE 1" = 1'-0"

11.86 SQUARE FEET

**SIGN DETAILS**

- 1 NON-ILLUMINATED, 1/4" THICK ALUMINUM
- 2 1/4" STUDS, 4" LONG FOR INSTALL. 4 studs per letter
- 3 PAINTED RED
- 4 Wall construction: Standard corrugated metal

FACE COLOR - WHITE

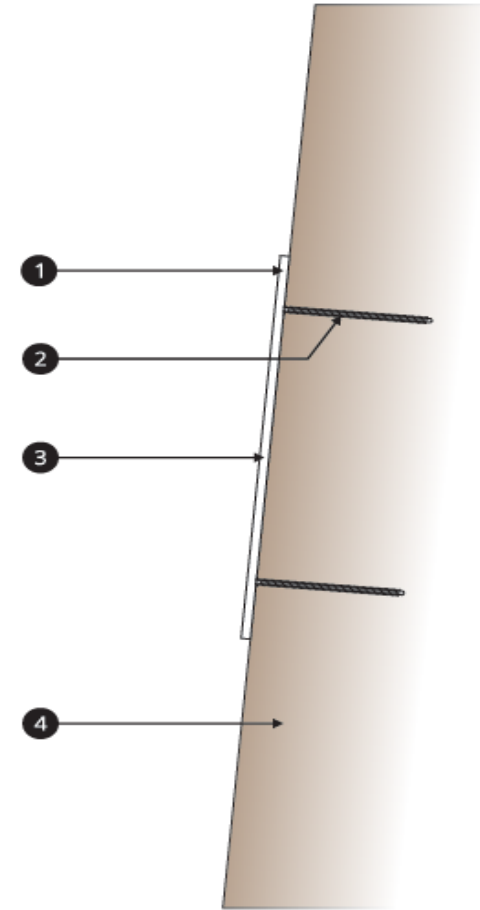

SECTION DETAIL

NOT TO SCALE

**DAMMON**  
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LOUISIANA & MISSISSIPPI  
Baton Rouge, LA 70802-3432 Fax: 504-541-1992  
www.dammonengineering.com  
info@dammonengineering.com

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DRAWING NO.  
**029714**

SIGN NO.  
**1.0**

REVISION NO.  
**1**

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ANDY WASSERSTROM  
PROJECT MANAGER:  
C. WINSTEAD  
DESIGNER:  
GMB

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**ASG**  
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